

ACTIVITY DETERMINATION

Project No. BGZEG

Having regard to the Determination Recommendation Report, the Statement of Compliance and the Review of Environmental Factors for this project addressing matters under Part 5 of the *Environmental Planning and Assessment Act 1979*, I determine that the activity proceed as described below and subject to the identified requirements set out in **Schedule 1**.

SITE IDENTIFICATION		
STREET ADDRESS		
Unit/Street No	Street or property name	
75-77	Sheppard Street	
Suburb, town or locality		Postcode
Casino		2470
Local Government Area(s)	Real property description (Lot and	d DP)
Richmond Valley	Lots 761 & 762 in DP 1155484	
ACTIVITY DESCRIPTION		
	ry ng houses comprising 4 x 2 bedroom and encing, surface parking for 7 cars, and co	

^{1.} Conflict of interest includes actual and potential. A conflict of interest includes pecuniary i.e. financial interests to you or a related party or non-pecuniary i.e. benefits to relatives, friends, business associates and personal causes, etc. This includes "related persons" as defined in the Property, Stock and Business Agency Act 2002.

Signed.....Sleul

Dated...25 November 2023.....

Emma Nicholson
A/Head of Policy and Innovation
Land and Housing Corporation
Department of Planning & Environment

SCHEDULE 1

IDENTIFIED REQUIREMENTS

PART A - Standard Identified Requirements

THE DEVELOPMENT

The following Identified Requirements are to ensure that the residential activity is carried out in accordance with the plans / documents and any amendments arising from the Review of Environmental Factors under Part 5 of the Environmental Planning & Assessment Act 1979, Section 171 of the Environmental Planning and Assessment Regulation 2021 and the requirements of State Environmental Planning Policy (Housing) 2021.

1. The development shall be carried out substantially in accordance with the following plans / documents as modified below and by any of the undermentioned identified requirements:

Title / Name:	Drawing No. / Document Ref	Revision / Issue	Date [dd/mm/yyyy]	Prepared by:			
Architectural Plans- Appendix A							
Coversheet	A01	Rev A	03/05/2023	Barry Rush and Associates Pty Ltd			
Site Analysis Plan	A02	Rev A	03/05/2023	Barry Rush and Associates Pty Ltd			
Site Plan	A03	Rev A	03/05/2023	Barry Rush and Associates Pty Ltd			
General Arrangement Plan – Ground Level	A04	Rev A	03/05/2023	Barry Rush and Associates Pty Ltd			
General Arrangement Plan – First Level	A05	Rev A	03/05/2023	Barry Rush and Associates Pty Ltd			
General Arrangement Plan - Roof	A06	Rev A	03/05/2023	Barry Rush and Associates Pty Ltd			
Building Elevations	A07	Rev A	03/05/2023	Barry Rush and Associates Pty Ltd			
Building Sections	A08	Rev A	03/05/2023	Barry Rush and Associates Pty Ltd			

Title / Name:	Drawing No. / Document Ref	Revision /	Date [dd/mm/yyyy]	Prepared by:
External Colour Schedule	A09	Rev A	03/05/2023	Barry Rush and Associates Pty Ltd
Block Analysis Plan	A10	Rev A	03/05/2023	Barry Rush and Associates Pty Ltd
Shadow Diagrams Mid- Winter	A11	Rev A	03/05/2023	Barry Rush and Associates Pty Ltd
Views from Sun Diagrams	A12	Rev A	03/05/2023	Barry Rush and Associates Pty Ltd
Street Perspective	A13	Rev A	03/05/2023	Barry Rush and Associates Pty Ltd
Areas of Excavation and Fill	A14	Rev A	03/05/2023	Barry Rush and Associates Pty Ltd
Landscape Plans – Appe	ndix B			
Landscape Plan	LA 1 of 2	С	08/05/2023	Greenland Design
Landscape Details and Specification	LA 2 of 2	С	08/05/2023	Greenland Design
Stormwater Plans – App	endix C		1	
Cover Sheet and Drawing Schedule	SYD23062- SW000	P2	04/05/2023	Erbas Building Services Engineers
Erosion and Sedimentation Control Plan	SYD23062- SW001	P2	04/05/2023	Erbas Building Services Engineers
Stormwater Service – Ground Floor Plan	SYD23062- SW101	P3	30/08/2023	Erbas Building Services Engineers
Stormwater Service – First Floor Plan	SYD23062- SW102	P2	04/05/2023	Erbas Building Services Engineers
Stormwater Services - Roof Plan	SYD23062- SW103	P2	04/05/2023	Erbas Building Services Engineers
Stormwater Services Detail – Sheet 01	SYD23062- SW201	P2	04/05/2023	Erbas Building Services Engineers
Stormwater Services Detail – Sheet 02	SYD23062- SW202	P2	04/05/2023	Erbas Building Services Engineers
Survey Plan – Appendix	D		·	
Detail Survey	Sheet 1 of 1	-	01/05/2022	RPS Australia East Pty Ltd
Notification Plans - App	endix E			
BASIX Certification - Ap	pendix K			
BASIX Certificate	Basix Certification no. 1378175M_02	-	19/06/2023	Building Sustainability Assessments
NatHERS Certificate - A				
NatHERS Certificate	Certificate No 0008644670		19/06/2023	Building Sustainability Assessments

Title / Name:	Drawing No. / Document Ref	Revision / Issue	Date [dd/mm/yyyy]	Prepared by:
Specialist Reports				
Arboricultural Impact Assessment – Appendix J	F419	В	27/04/2023	Creative Planning Solutions
BCA Compliance Assessment Report- Appendix H	P230063 (2)	-	5/05/2023	BCA vision
Geotechnical Investigation - Appendix O	31895/6740D- G	-	August 2022	STS Geotechnics Pty Ltd
Traffic Impact Assessment- Appendix R	-	-	April 2023	Fernway Engineering
Waste Minimisation and Management Plan – Appendix Q	-	-	18/04/2023	Barry Rush & Associates Pty Ltd

- 2. All building work is to be undertaken in accordance with the National Construction Code and referenced Australian Standards.
- **3.** All commitments listed in the BASIX certificate and stamped plans shall be implemented.
- 4. All construction documentation and building work is to be certified in accordance with Section 6.28 of the Environmental Planning and Assessment Act 1979.
- 5. The land the subject of this determination shall be consolidated into a single lot. The plan of consolidation shall be lodged at the NSW Land Registry Services and shall be registered prior to the occupation of the development. A copy of the registered plan shall be provided to the Land & Housing Corporation.

At the time of lot consolidation, the easement for sewer that is 5m wide located at the northern Sheppard Street front boundary must be amended by; the removal of the upstream pipeline infrastructure that is east of the existing sewer manhole on 75 Sheppard Street and redefining the area of the easement for sewer based on the operational sewer infrastructure on the consolidated lot. Council will be required to sign the Section 88B instrument as a beneficiary of the easement and infrastructure.

OPERATIONAL MATTERS

The following Identified Requirements relate to the use of the site and are to ensure that the activity and its operation do not interfere with the amenity of the surrounding area.

Stormwater Run-off

6. Stormwater shall be collected within the site and conveyed in a pipeline to the appropriate gutter or drain under the control of Richmond Valley Council substantially in accordance with the approved concept stormwater drainage plans.

- 7. Alterations to the natural surface contours or surface absorption characteristics of the site shall not impede, increase, or divert natural surface water runoff so as to cause a nuisance to adjoining property owners.
- **8.** All driveways shall be graded in such a manner as to provide continuous surface drainage flow paths to the appropriate points of discharge.
- **9.** To prevent water from entering buildings, surface waters shall be collected and diverted clear of the buildings by a sub-surface / surface drainage system.

Vehicular Access & Parking

- 10. A concrete vehicular crossing and layback shall be provided at the entrance / exit to the property. The crossing and layback shall be constructed in accordance with Richmond Valley Council's standard requirements for residential crossings. Council shall be provided with plans for the crossing and layback together with the payment of any council inspection fees.
- 11. Particular care shall be taken in the location of the vehicular crossing and layback to avoid poles, pits etc. The cost of any necessary adjustments to utility mains and services associated with the construction of the layback / driveway shall be borne by the Land & Housing Corporation. Obsolete gutter layback(s) shall be constructed as kerb in accordance with Richmond Valley Council's standards.

Note

It is recommended that discussion be held with the relevant authorities before construction works commence.

12. Car parking spaces and driveways shall be constructed of concrete or other approved hard surfaced materials. The spaces must be clear of obstructions and columns, permanently line marked and provided with adequate manoeuvring facilities. The design of these spaces must comply with AS 2890.1.

Site Works

- 13. All soil erosion and sediment control measures required to be put in place prior to the commencement of site preparation / construction works shall be maintained during the entire period of the works until all the disturbed areas are restored by turfing, paving or revegetation. Soil erosion and sediment control measures shall be designed in accordance with the guidelines set out in the Blue Book *Managing Urban Stormwater:* Soils and Construction (4th edition, Landcom, 2004).
- 14. An appropriately qualified person shall design retaining walls or other methods necessary to prevent the movement of excavated or filled ground, including associated stormwater drainage measures.

Building Siting

15. All buildings shall be sited well clear of any easements affecting the site. The builder shall ascertain if any easements do exist and, if they do, obtain full details of such prior to construction commencing.

Smoke Detection System(s)

- 16. Smoke detection systems shall be installed throughout the building(s) in accordance with requirements of Clause E2.2a of the Building Code of Australia. Detectors and alarms shall comply with AS 3786 and AS 1670 and must:
 - i. be connected to a permanent 240V power supply; and
 - ii. be provided with a battery backup to activate the alarm unit in the event of failure of the permanent power supply.

Site Soil Contamination

17. If the site is identified as being potentially affected by soil contamination, it shall be inspected by a suitably qualified person to identify any contaminated or hazardous material present. A proposal for remediation shall be prepared, which may include preparation of a Remedial Action Plan, and remediation shall be carried out in accordance with the proposal. A Validation Report, prepared in accordance with Environment Protection Authority requirements, shall be obtained from a qualified expert on completion of the remediation work to verify that the site is suitable for the intended residential use. A copy of the Validation Report shall be provided to the Land & Housing Corporation on completion of the remediation works.

Landscaping

- 18. Landscaping shall be carried out substantially in accordance with the approved landscape plan(s) and maintained for a period of 12 months by the building contractor. Richmond Valley Council shall be consulted in relation to the planting of any street trees.
 - The 4 trees located within the front setback of the site must be planted a minimum of 1m from the 1.5m wide drainage easement.
- 19. All scheduled plant stock shall be pre-ordered, prior to commencement of construction or 3 months prior to the commencement of landscape construction works, whichever occurs sooner, for the supply to the site on time for installation. The builder shall provide written confirmation of the order to the Land & Housing Corporation.

Fencing

20. All front fencing and gates shall be constructed wholly within the boundaries of the site. Any gates associated with the fencing shall swing inwards towards the site.

Provision of Letterbox Facilities

21. Suitable letterbox facilities are to be provided in accordance with Australia Post specifications.

Public Liability Insurance

22. A valid public liability insurance policy of at least \$10M shall be maintained throughout the site preparation / construction works by the contractor.

PRIOR TO ANY WORK COMMENCING ON THE SITE

The following Identified Requirements are to be complied with prior to any work commencing on the site, including site preparation.

Disconnection of Services

- 23. All services that are required to be disconnected shall be appropriately disconnected and made safe prior to commencement of the site preparation / construction works. The various service authorities shall be consulted regarding their requirements for the disconnection of services.
- **24.** All existing services within the boundary to remain live shall be identified, pegged and made safe.

Prior to Commencement

- 25. The builder shall notify the occupants of premises on either side, opposite and at the rear of the site a minimum of 5 working days prior to commencement of work. Such notification shall be clearly written on an A4 size paper giving the date work will commence and be placed in the letterbox of every premise (including every unit in a multi-unit residential building or mixed-use building). The works shall not commence prior to the date that is stated in the notice letter.
- 26. Prior to the commencement of work, a Work Plan shall be prepared by a competent person(s) in accordance with AS 2601 and shall be submitted to the Land & Housing Corporation. The Work Plan shall outline the identification of any hazardous materials (including surfaces coated with lead paint), method of works, the precautions to be employed to minimise any dust nuisance and the disposal methods for all materials.

Utilities Service Provider Notification

27. The construction plans shall be submitted to the appropriate water utility's office (e.g., local council) to determine whether or not the development will affect the utility's sewer and water mains, stormwater drains and any easements.

Note:

If the development complies with water utility's requirements, the plans will be stamped indicating that no further requirements are necessary.

Council Notification

28. Richmond Valley Council shall be advised in writing, of the date it is intended to commence work, including site preparation. A minimum period of 5 working days notification shall be given.

Site Safety

- **29.** A sign shall be erected in a prominent position on any site on which site preparation or building work is being carried out:
 - (a) showing the name, address and telephone number of the responsible Land & Housing Corporation officer for the work, and
 - (b) showing the name of the principal contractor (if any) and a telephone number on which that person may be contacted outside working hours, and

(c) stating that unauthorised entry to the work site is prohibited.

The sign shall be maintained while the work is being carried out but shall be removed when the work has been completed.

Note:

This requirement does not apply in relation to building work that is carried out inside an existing building that does not affect the external walls of the building.

30. A minimum 1.8m high security fence or Class A / Class B (overhead) hoarding must be erected between the work site and any public place prior to site preparation / construction. Access to the site shall be restricted to authorised persons only and the site shall be secured against unauthorised entry when site preparation / construction work is not in progress, or the site is otherwise unoccupied.

Note.

Approval from the relevant road's authority will be required under Section 138 of the Roads Act 1993 where a Class A or B hoarding encroaches onto the footpath of / or a public thoroughfare within a classified road.

31. No building or other materials are to be stored on the footpath or roadway.

Site Facilities

- **32.** The following facilities shall be installed on the site:
 - (a) Toilet facilities shall be provided at the rate of 1 toilet for every 20 persons or part thereof employed at the site. Each toilet provided shall be a standard flushing toilet and shall be connected to a public sewer or if connection to a public sewer is not practicable, to an accredited sewerage management facility provided by Richmond Valley Council or if this is not practicable to some other council approved management facility.
 - (b) Adequate refuse disposal methods and builders' storage facilities. Builders' wastes, materials or sheds shall not to be placed on any property other than that which this approval relates to.
- **33.** Access to the site shall only be provided via an all-weather driveway on the property and is not to be provided from any other site.

Protection of Trees

34. Trees and other vegetation that are to be retained on site shall be protected prior to the commencement of works and for the duration of the construction period in accordance with the details provided in the Arboricultural Impact Assessment report.

Waste Management

35. A final Waste Management Plan shall be prepared and submitted to the Land & Housing Corporation by the building contractor prior to the commencement of site preparation / construction. The plan shall detail the amount of waste material and the destination of all materials, recyclable and non-recyclable.

PRIOR TO ANY CONSTRUCTION WORK COMMENCING ON SITE

The following Identified Requirements are to be complied with prior to any construction works occurring on the site.

Service Authority Clearances

36. A compliance certificate, or other evidence, shall be obtained from the relevant water utility provider (e.g., the local Council), confirming service availability prior to work commencing.

Note:

Payment of water and/or sewer service charges and/or a notice of requirements for works to be carried out during construction / prior to occupation may be applicable prior to issue of the compliance certificate.

- **37.** A written clearance from an electricity supply authority stating that electrical services are available to the site, or that arrangements have been entered into for the provision of services to the site, shall be obtained prior to work commencing.
- **38.** A certificate from an approved telecommunications carrier certifying that satisfactory arrangements have been made for the provision of underground telephone services, to the site and to each dwelling, shall be obtained prior to work commencing.
- **39.** Where the site is to be connected to reticulated gas, a certificate from an approved gas carrier to certify that satisfactory arrangements have been made to ensure the provision of underground gas services to each dwelling in the development shall be obtained prior to work commencing.

Stormwater Disposal

40. A detailed stormwater drainage plan(s), substantially in accordance with the approved concept stormwater drainage plan(s), shall be prepared and submitted to the Land & Housing Corporation. Any on-site detention system shall be designed in accordance with the relevant catchment authority's requirements (e.g. the Upper Parramatta River Catchment Trust On-site Detention Handbook) and/or Richmond Valley Council's drainage code.

DURING CONSTRUCTION WORKS

The following Identified Requirements are to be complied with whilst site preparation and construction works are occurring on the site.

Landfill

- **41.** Where site filling is necessary, a minimum of 95% standard compacting shall be achieved and certified by a NATA registered Soils Lab.
- **42.** Land fill materials must satisfy the following requirements:
 - i. be Virgin Excavated Natural Matter (VENM);
 - ii. be free of slag, hazardous, contaminated, putrescible, toxic or radio-active matter; and
 - iii. be free of industrial waste and building debris.

Heritage

- 43. Historic and indigenous archaeological sites and relics are protected under the Heritage Act 1977 and National Parks and Wildlife Act 1974, respectively. Should any relics be uncovered during the course of the approved works, work must cease immediately in the affected area. Subsequently, in cases where historical items have been uncovered, the Department of Planning and Environment must be contacted.
- 44. All workers / contractors on the site shall be informed of their obligations, under the Heritage Act and *National Parks and Wildlife Act 1974*, that it is illegal to disturb, damage or destroy a relic without the prior approval.

Site Preparation

- **45.** Hazardous or intractable wastes, including all asbestos laden waste, arising from the site preparation process shall be removed and disposed of in accordance with the requirements of SafeWork NSW and the Department of Planning and Environment.
- **46.** Documentary evidence, in the form of tip receipts from an approved Waste Management Facility, shall be obtained by the contractor and submitted to the Land & Housing Corporation demonstrating the appropriate disposal of waste.
- **47.** Site preparation procedures shall maximise the reuse and recycling of demolished materials in order to reduce the environmental impacts of waste disposal.
- **48.** During site preparation, the public footpath and the public road shall not be obstructed by any vehicles. The public road and footpath shall be swept (not hosed) clean of any material, including clay, soil and sand.
- **49.** All vehicles leaving the site with materials shall have their loads covered and vehicles shall not track soil and other material onto the public roads and footpaths. The footpath shall be suitably protected against damage when plant and vehicles access the site. All loading of vehicles with demolished materials shall occur on site.

Survey Reports

50. Survey reports shall be submitted by the building contractor to the Land & Housing Corporation prior to the placement of the footings / slab and on completion of the dwellings to verify the correct position of the structures in relation to the allotment boundaries.

Hours of Site preparation / Construction / Civil Work

51. Site preparation / construction / civil work shall only occur on the site between the hours of 7.00am to 5.00pm Monday to Saturday with no work permitted on Sundays or public holidays.

Excavation & Backfilling

52. All excavations and backfilling associated with the site preparation or erection of building(s) shall be executed safely and in accordance with appropriate professional standards. All such work shall be guarded and protected to prevent it from being dangerous to life or property.

Pollution Control

- 53. Any noise generated during the site preparation and construction of the development shall not exceed the limits specified in the July 2009 Interim Construction Noise Guidelines, published by the former Department of Environment and Climate Change.
- **54.** No fires shall be lit or waste materials burnt on the site.
- **55.** No washing of concrete forms or trucks shall occur on the site.
- **56.** Any contamination / spills on the site during construction works shall be actively managed and reported immediately to appropriate regulatory authorities to minimise any potential damage to the environment.
- **57.** Dust generation during site preparation / construction shall be controlled using regular control measures such as on site watering or damp cloth fences.
- **58.** All vehicles transporting loose materials and travelling on public roads shall be secured (i.e. closed tail gate and covered) to minimise dust generation.
- **59.** Non-recyclable waste and containers shall be regularly collected and disposed of at a licensed landfill or other disposal site in accordance with details set out in the final Waste Management Plan.

Impact of Construction Works

- **60.** The Land & Housing Corporation shall bear the cost of any necessary adjustments to utility mains and services.
- 61. Care shall be taken to prevent any damage to adjoining properties. The building contractor shall be liable to pay compensation to any adjoining owner if, due to site preparation /construction works, damage is caused to such adjoining property.

Termite Protection

62. To protect buildings from subterranean termite, termite barriers installed in accordance with AS 3660.1, shall be placed on the underside and in penetrations of the concrete slab floor.

In addition, a durable notice must be permanently fixed inside the meter box indicating:

- (a) the method of protection,
- (b) the date of installation of the system,
- (c) where a chemical barrier is used, its life expectancy as listed on the National Registration Authority label, and
- (d) the need to maintain and inspect the system on a regular basis.

PRIOR TO OCCUPATION OF THE DEVELOPMENT

The following Identified Requirements are to be complied with prior to the occupation of the development.

General

63. The use or occupation of the development shall not commence until all the Identified Requirements of this determination have been complied with.

Council Infrastructure Damage

64. The cost of repairing any damage caused to Richmond Valley Council's assets in the vicinity of the site as a result of site preparation / construction works shall be met in full by the building contractor.

Stormwater Drainage

- 65. Prior to occupation, a Work As Executed Plan shall be prepared by the building contractor clearly showing all aspects of the constructed stormwater drainage system, including any rainwater tank/s and on-site detention system. The plan shall demonstrate general compliance with the approved concept stormwater drainage plan(s) and shall include:
 - sufficient levels and dimensions to verify the constructed storage volumes; and
 - location and surface levels of all pits; and
 - invert levels of the internal drainage lines, orifice plates fitted and levels within the outlet control pits; and
 - finished floor levels of all structures; and
 - verification that any required trash screens have been installed; and
 - locations and levels of any overland flow paths; and
 - verification that any drainage lines are located wholly within easements, where applicable.

The Work-As-Executed Plan information shall be shown on the final civil works drawings.

PART B – Additional Identified Requirements

Site Specific Requirements

66. Prior to the occupation of the development LAHC must consult with Richmond Valley Council on the design and location of the bus stop. The bus stop must be constructed and operational prior to the occupation of the development.

Requirements Resulting from Council Comments

67. Where required by the relevant legislation, approvals for work within the Sheppard Street reserve shall be obtained from Richmond Valley Council, prior to these works taking place. These works may include works such as the relocation of the bus stop, construction of vehicle crossings, services, and other infrastructure.

- 68. The works to connect private drainage to the public drainage infrastructure in Sheppard Street will require an inspection by Engineers of Richmond Valley Council prior to backfilling.
- 69. The driveway must have tapers adjacent to the kerbline in accordance with R-05 of the Northern Rivers Local Government Development Design and Construction Manual.
- 70. The internal stormwater drainage network is to be connected into the existing interallotment drainage system which will avoid the further connection to the kerb in Sheppard Street and avoid excavation of the driveway crossing at No.73 Sheppard Street.
- 71. The kerb on the low (western) side of the driveway is to extend to be integrated with SWP1.
- 72. Developer Contributions in accordance with Section 64 of the Local Government Act, 1993 and Chapter 6 Part 2 Division 5 of the Water Management Act, 2000 for Water and Sewer Headworks Services area payable to Richmond Valley Council (RVC) prior to the commencement of works. Section 64 Contributions payable are:

Section 64 Local Govt Act & Water Management Act 2000 Levy Area - Casino	TechOne Code	No. of ET's	\$ / ET for 2023-2024	Amount Payable (\$)
RVC Water Headworks	WatS64Hwks	2.0	\$ 9,630.50	\$ 19,261.00
RVC Sewerage Headworks	SewS64Hwks	3.0	\$ 8,000.00	\$ 24,000.00
Rous Water # Water Headworks	Rous64Hwks	N/A	N/A	\$ NIL
Total Section (current @ 24/7/2023 but generally a Payments will be in accordance with C	\$43,261.00			

73. To ensure that the 30m³ rainwater tank has sufficient capacity during storm events, the rainwater tank must be plumbed to the toilets, washing machines and landscaped areas of each dwelling. Details are to be provided on the construction drawings.

ADVISORY NOTES

- i. Approval of this development activity does not imply or infer compliance with Section 23 of the *Disability Discrimination Act 1992*. Refer to AS 1428.1 and the Building Code of Australia for detailed guidance.
- ii. Information regarding the location of underground services may be obtained from Dial Before You Dig at www.1100.com.au or by dialing 1100.



Decision Statement

SITE IDENTIFICATION		
STREET ADDRESS		
Unit/Street No	Street or property name	
75-77	Sheppard Street	
Suburb, town or locality		Postcode
Casino		2470
Local Government Area(s)	Real property description (Lot and DF	P)
Richmond Valley	Lots 761 & 762 in DP1155484	
ACTIVITY DESCRIPTION		
Provide a description of the activ	vity	
The construction of 6 multi dwelling	g houses comprising 4 x 2 bedroom and 2 x 3	bedroom dwellings,
with associated landscaping and fe	encing, surface parking for 7 cars, and consolid	dation into a single lot

The Land & Housing Corporation (LAHC) has proposed the above activity under the provisions of *State Environmental Planning Policy (Housing)* 2021 (Housing SEPP) which requires determination under Part 5 of the *Environmental Planning & Assessment Act* 1979 (EP&A Act). This Decision Statement relates to the Review of Environmental Factors (REF) for the above activity prepared under Part 5 of the EP&A Act and the *Environmental Planning and Assessment Regulation* 2021.

Based on the REF document and supporting documentation, including advice from Richmond Valley Council, a decision to proceed with the proposed activity has been made. This decision included consideration of the following:

Significant Impact on the Environment

- The proposed activity is not likely to have a significant impact on the environment and therefore an EIS is not required.
- The proposed activity will not be carried out in a declared area of outstanding biodiversity value and
 is not likely to significantly affect threatened species, populations or ecological communities, or their
 habitats or impact biodiversity values, meaning a SIS and/or BDAR is not required.

Reasons for the Decision

- Following an assessment of the proposed activity and associated environmental impacts within the REF document it was decided that the proposed development will have economic and social benefits and any minor short-term impacts on the environment or surrounding properties can be appropriately mitigated.
- The proposed development will assist in the provision of much needed social and affordable housing and assist in addressing the existing and growing demand for housing in the local government area.

Decision Statement: Proposed multi-dwelling housing at 75-77 Sheppard Street, Casino

Mitigation Measures

 Mitigation measures are required to minimise or manage environmental impacts and are detailed throughout the REF and specifically within Section 7. All mitigation measures are detailed as Identified Requirements within the Activity Determination. Additional mitigation measures, detailed in the Activity Determination have been imposed to minimise the impact on the surrounding environment, ensure appropriate site safety and to ensure legislative compliance.

Signed.....

Dated...25 November 2023.....

Emma Nicholson
Acting Head of Policy and Innovation
Land and Housing Corporation
Department of Planning & Environment

GENERAL HOUSING DEVELOPMENT

75-77 SHEPPARD STREET, CASINO LOTS 761 & 762 in DP 1155484



DRAWING SCHEDULE ARCHITECTURAL REFERENCE No COVER PAGE SITE ANALYSIS PLAN SITE PLAN GROUND FLOOR PLAN FIRST FLOOR PLAN ROOF PLAN ELEVATIONS SECTIONS FINISHES SCHEDULE BLOCK ANALYSIS PLAN SHADOW DIAGRAMS MID WINTER VIEWS FROM SUN DIAGRAM STREET PERSPECTIVE AREAS OF EXCAVATION & FILL CIVIL COVER SHEET, LEGEND & DRAWING SCHEDULE SW000 P2 EROSION & SEDIMENT CONTROL PLAN GROUND FLOOR PLAN SW001 SW101 FIRST FLOOR PLAN ROOF PLAN SW103 DETAIL SHEET 1 DETAIL SHEET 2 SW202 LANDSCAPE LA 1 OF 2 LA 2 OF 2 LANDSCAPE PLAN LANDSCAPE DETAILS & SPECIFICATION

S SHT 1 OF 1 -

DETAIL SURVEY
BY: RPS AUSTRALIA EAST PTY LTD

SURVEY REFERENCE 151687

PERSPECTIVE

1241		4
LOCKED BAG 5022		E
NSW PARRAMATTA NSW 2124 PHONE No 1800 738 718	- II.	ASF
GOVERNMENT https://www.dpie.nsw.gov	.au/lana-ana-nousing-corporation	v

Barry Rush & Associates Pty Ltd
Architects. Nominated Architect: Barry John Rush

		ARCHITECT BARRY RUSH & ASSOCIATES PTYLTD PH (02) 9555 8028	STRUCTURAL CONSULTANT
		PROJECT MANAGER LAND & HOUSING CORPORATION PH (02) 8753 9000	CIVIL CONSULTANT ERBAS AND ASSOCIATES PTY LTD PH (02) 9437 1022
DATE	NOTATION/AMENDMENT	LANDSCAPE CONSULTANT	HYDRAULIC & ELECTRICAL CONSULTANT
DO NOT	SCALE DRAWINGS. CHECK ALL DIMENSIONS ON SITE. FIGURED DIMENSIONS TAKE PRECEDENCE.		ERBAS AND ASSOCIATES PTY LTD PH (02) 9437 1022
			•

DEVELOPMENT DATA


Job Reference	BGZEG
Locality / Suburb	Casino
Street Address	75-77 Sheppard Sreet
Lot & DP	Lots 2761 and 762 in DP 1155484
Site Area	1354.9 m ² by title
Existing Lots	2
Proposed GFA	505.6 m²
No. of Dwellings	4 x 2 Bed + 2 x 3 Bed = 6 Dwellings


	Control	Requirement	Proposed
HEIGHT	Richmond Valley Council LEF Housing SEPP LRHDG Rear 40% of Site	8.5m 9.0m 4.5m	6.3m to ceiling 7.8m to top of roof rear 40% of site < 4.5m
FSR	Richmond Valley Coast DCP	0.5:1 (631.5m²)	0.37:1 (505.6m²)
	Housing SEPP	0.5:1	0.37:1 (505.6m²)
LOT SIZE & WIDTH	Richmond Valley Coast DCP	Site 1000 m² Width 20m	Site 1354.9m² Width 34m
SETBACKS	Richmond Valley Coast DCP multi - dwelling	Front Setback 6.0m	6.0-8.5m to Building
	LRHDG	Side Setback = H - 3m	3.0-5.2m to Building East (front) - 5.2m to building 3.2m to awning East (rear) - 3m West - 5m
	LRHDG	Rear Setback = 6m	4m to Building 2m to awning
PARKING	Housing SEPP	1 x (no. 2 Beds) = 4 1.5 x (no. 3 Beds) = 3	7 car spaces
BICYCLE PARKING	LRHDG	1 space per Dwelling = 6	Bicycles to be stored in unit POS
POS Private open space	LAHC Dwelling Requirements	1 bed Dwelling = 8m² 2 bed Dwelling = 10m² 3 bed Dwelling = 12m²	All POS > 25m²
	Richmond Valley Coast DCP multi - dwelling	1+2 bed Dwelling = 16m ² 3 bed Dwelling = 25m ²	All POS > 25m²
SOLAR ACCESS	Housing SEPP	70% for 3hrs in Mid-Winter = 4.2	5 = 83%


Site Area = 1354.9 m ² by title						SOLAR ACCESS	
DWELLINGS	Number	Type*	Beds	Area* (m²)	POS*	LIVING	POS
	1	T/H	2	80	26	6 hr	6 hr
	2	T/H	2	80	27	6 hr	6 hr
	3	T/H	3	99	47	6 hr	6 hr
	4	T/H	3	99	30	2 hr	3 hr
	5	VILLA	2	74.5	60	4 hr	3 hr
	6	VILLA	2	73	31	3 hr	2 hr


HOUSING DEVELOPMENT 75-77 SHEPPARD STREET CASINO, NSW LOTS 761 & 762 in DP 1155484


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COVER PAGE		DATE:	SCALE:	PROJ:	PROJECT No.
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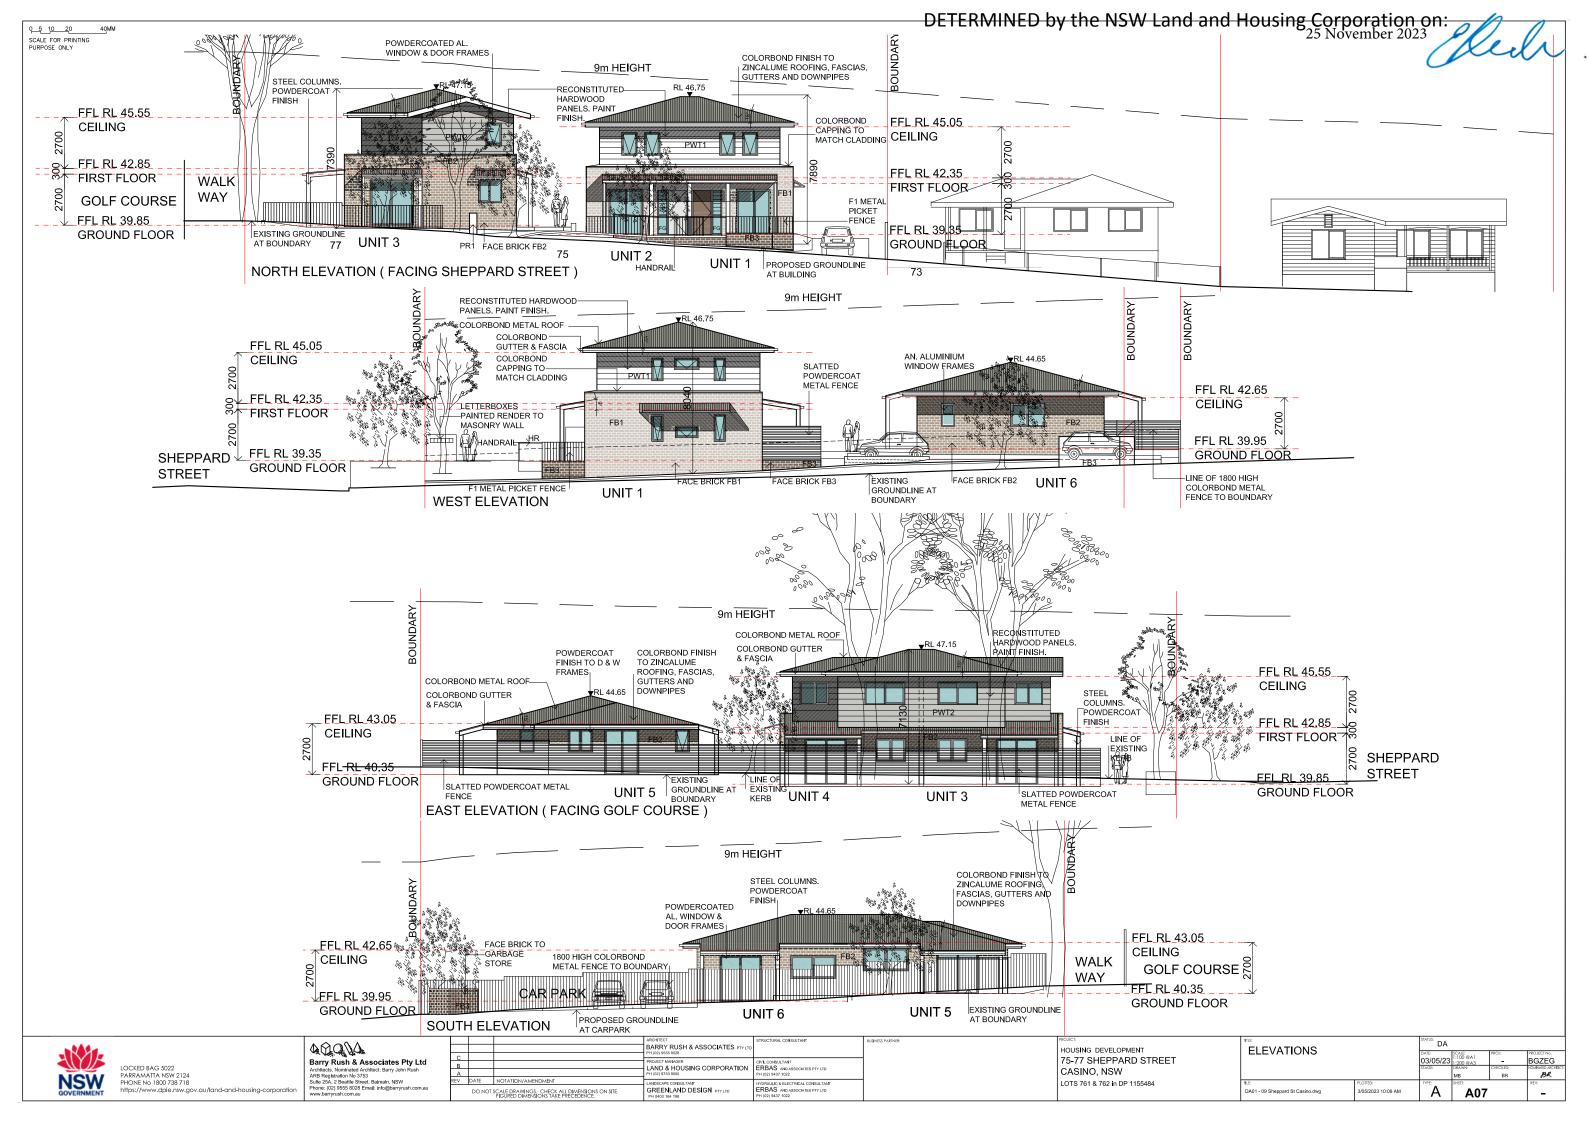


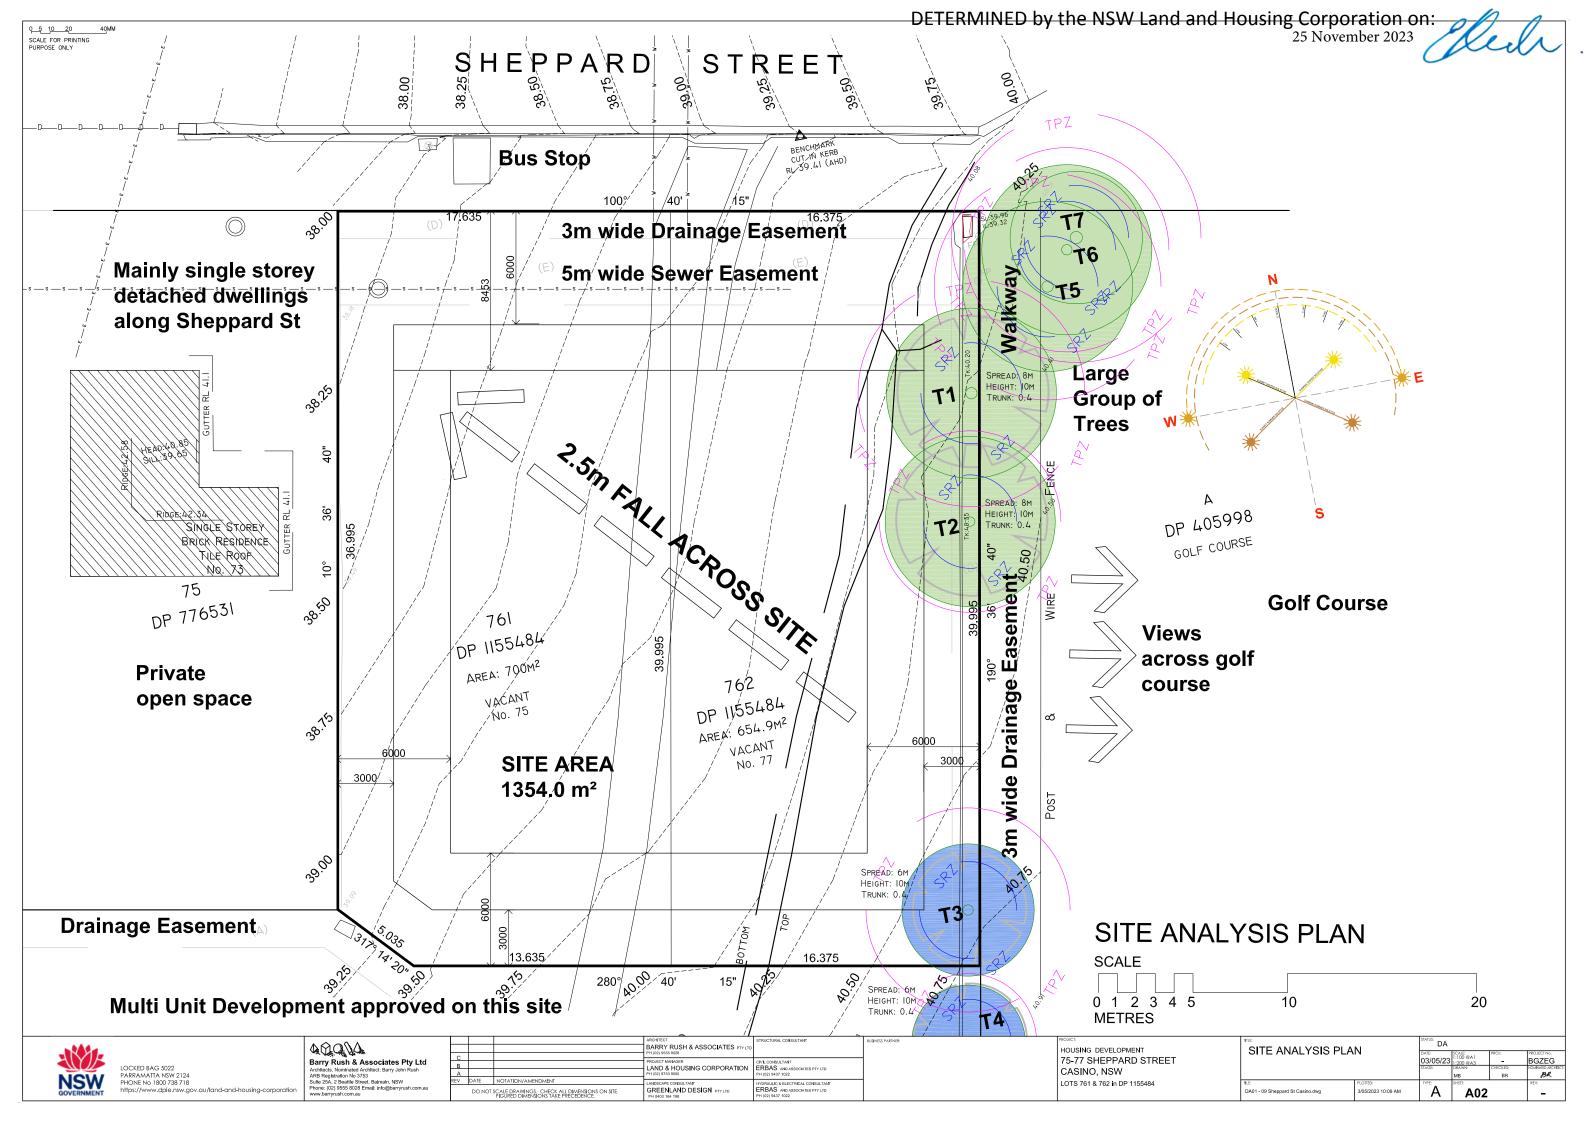


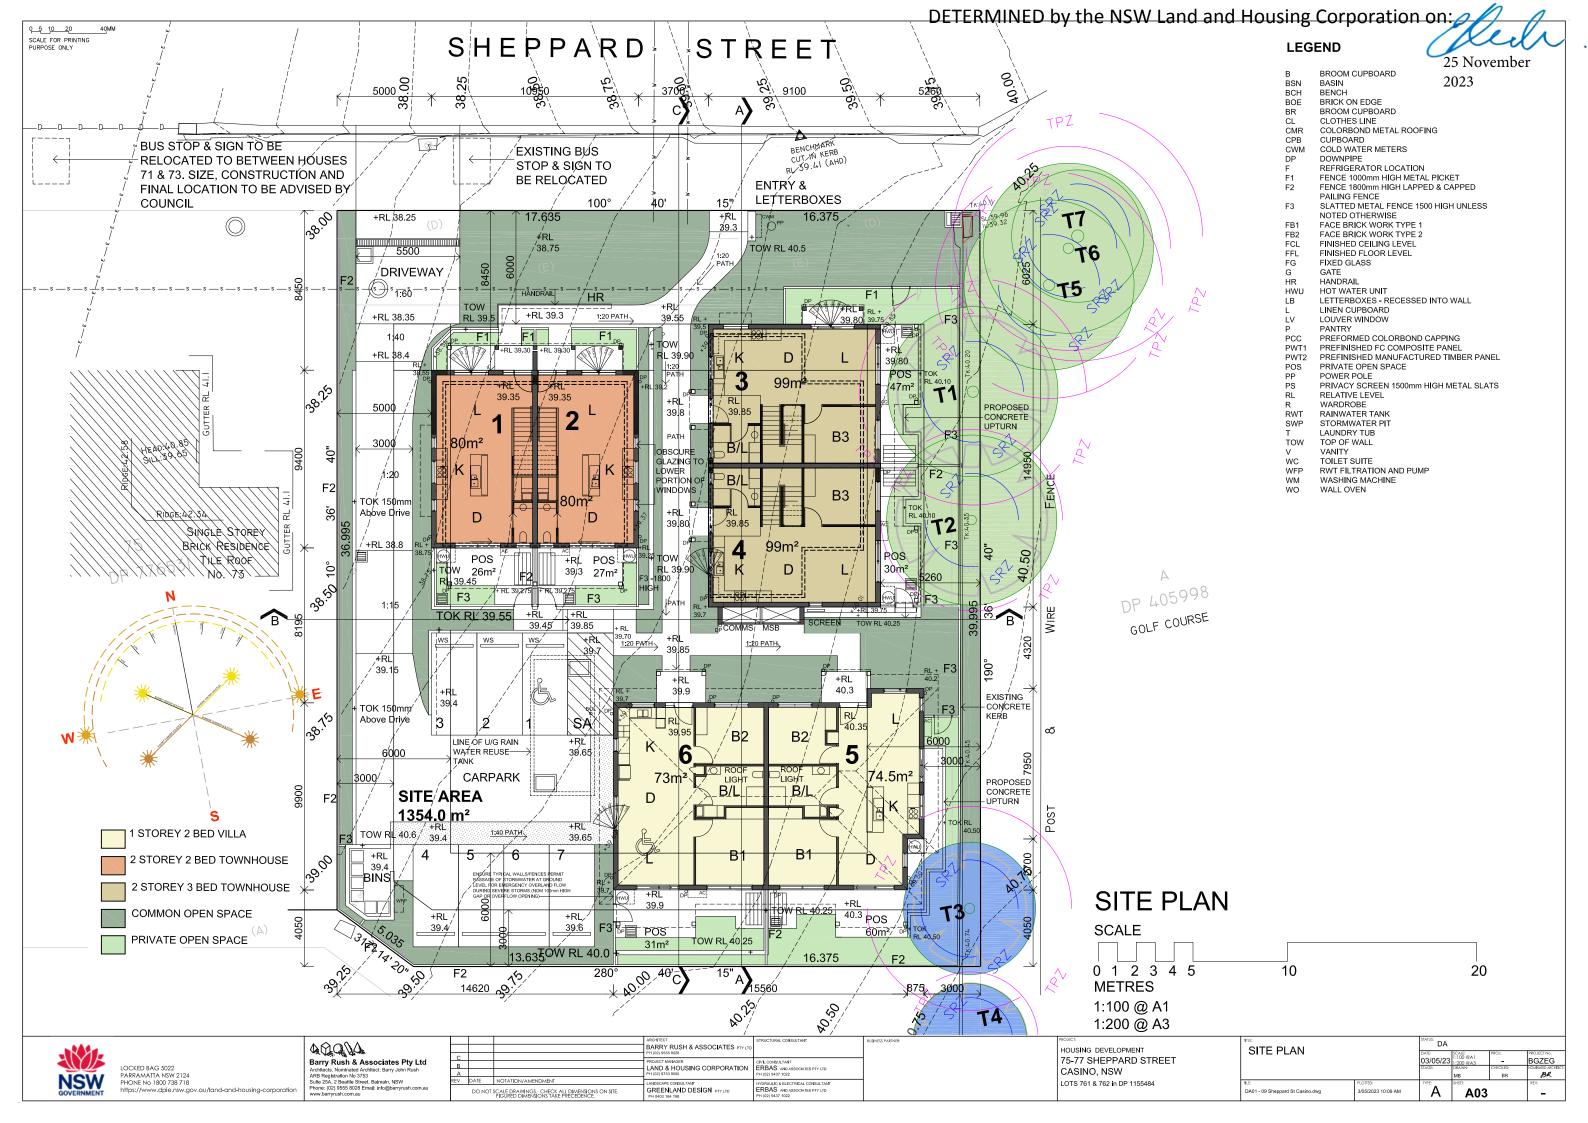

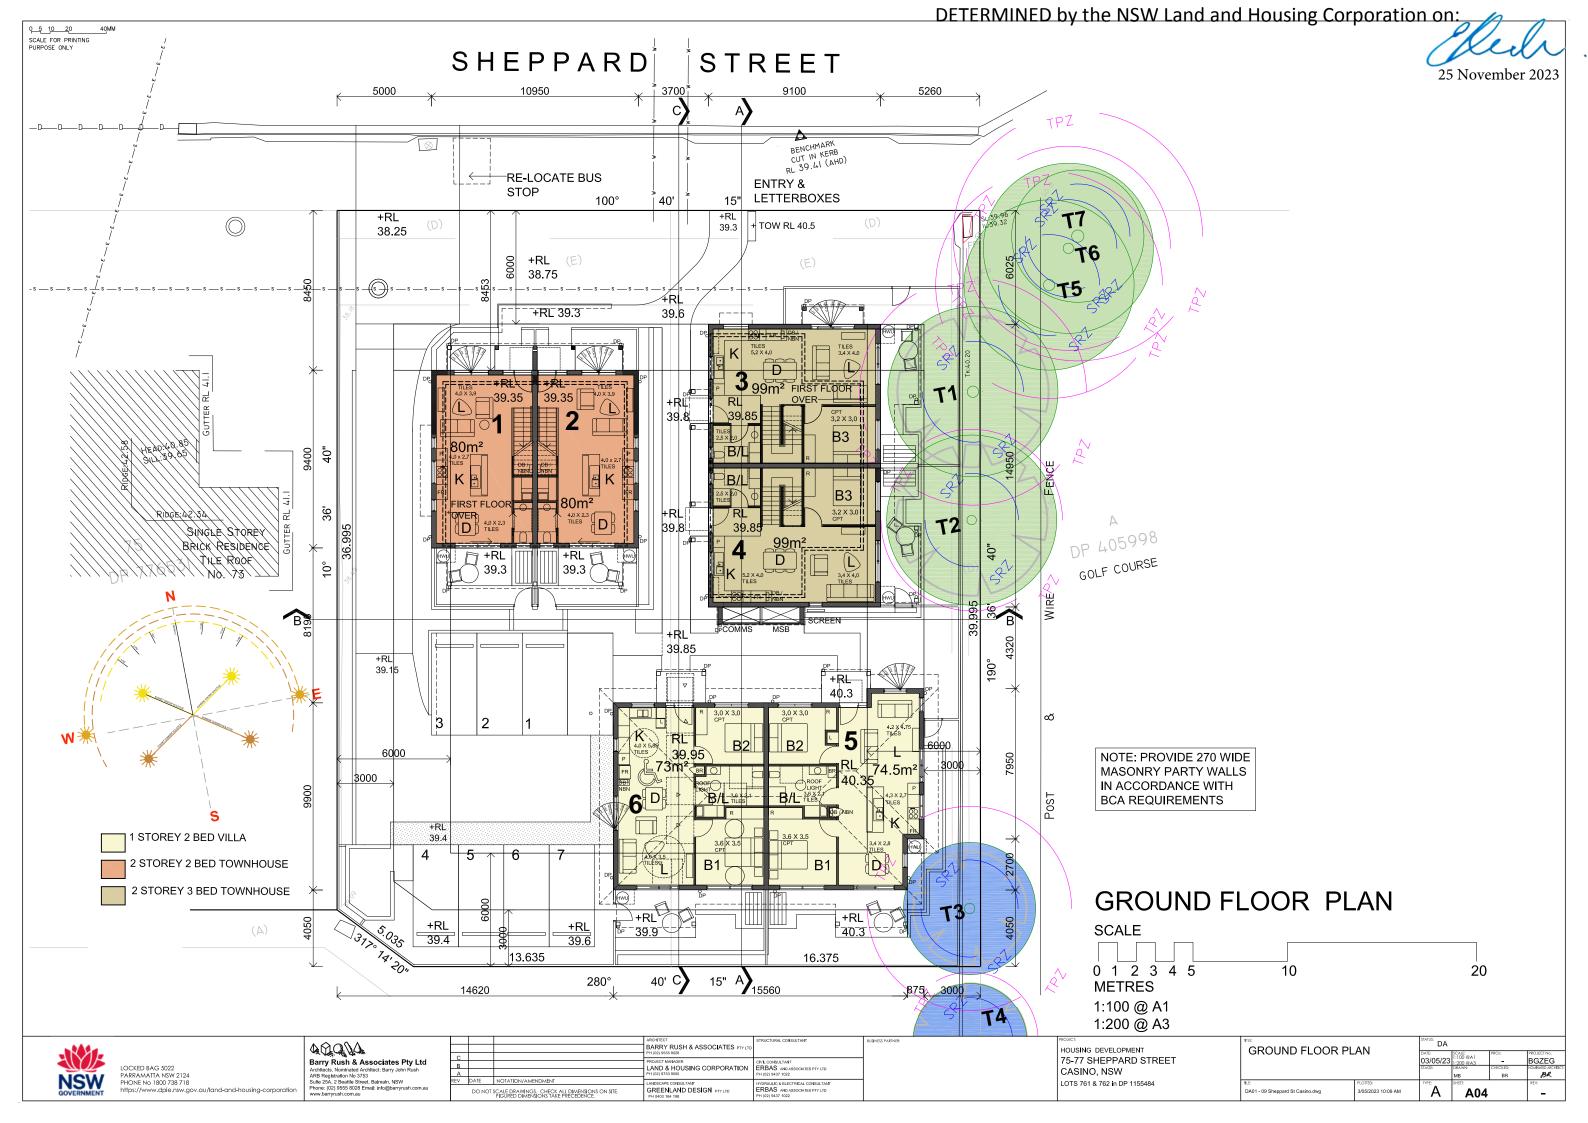

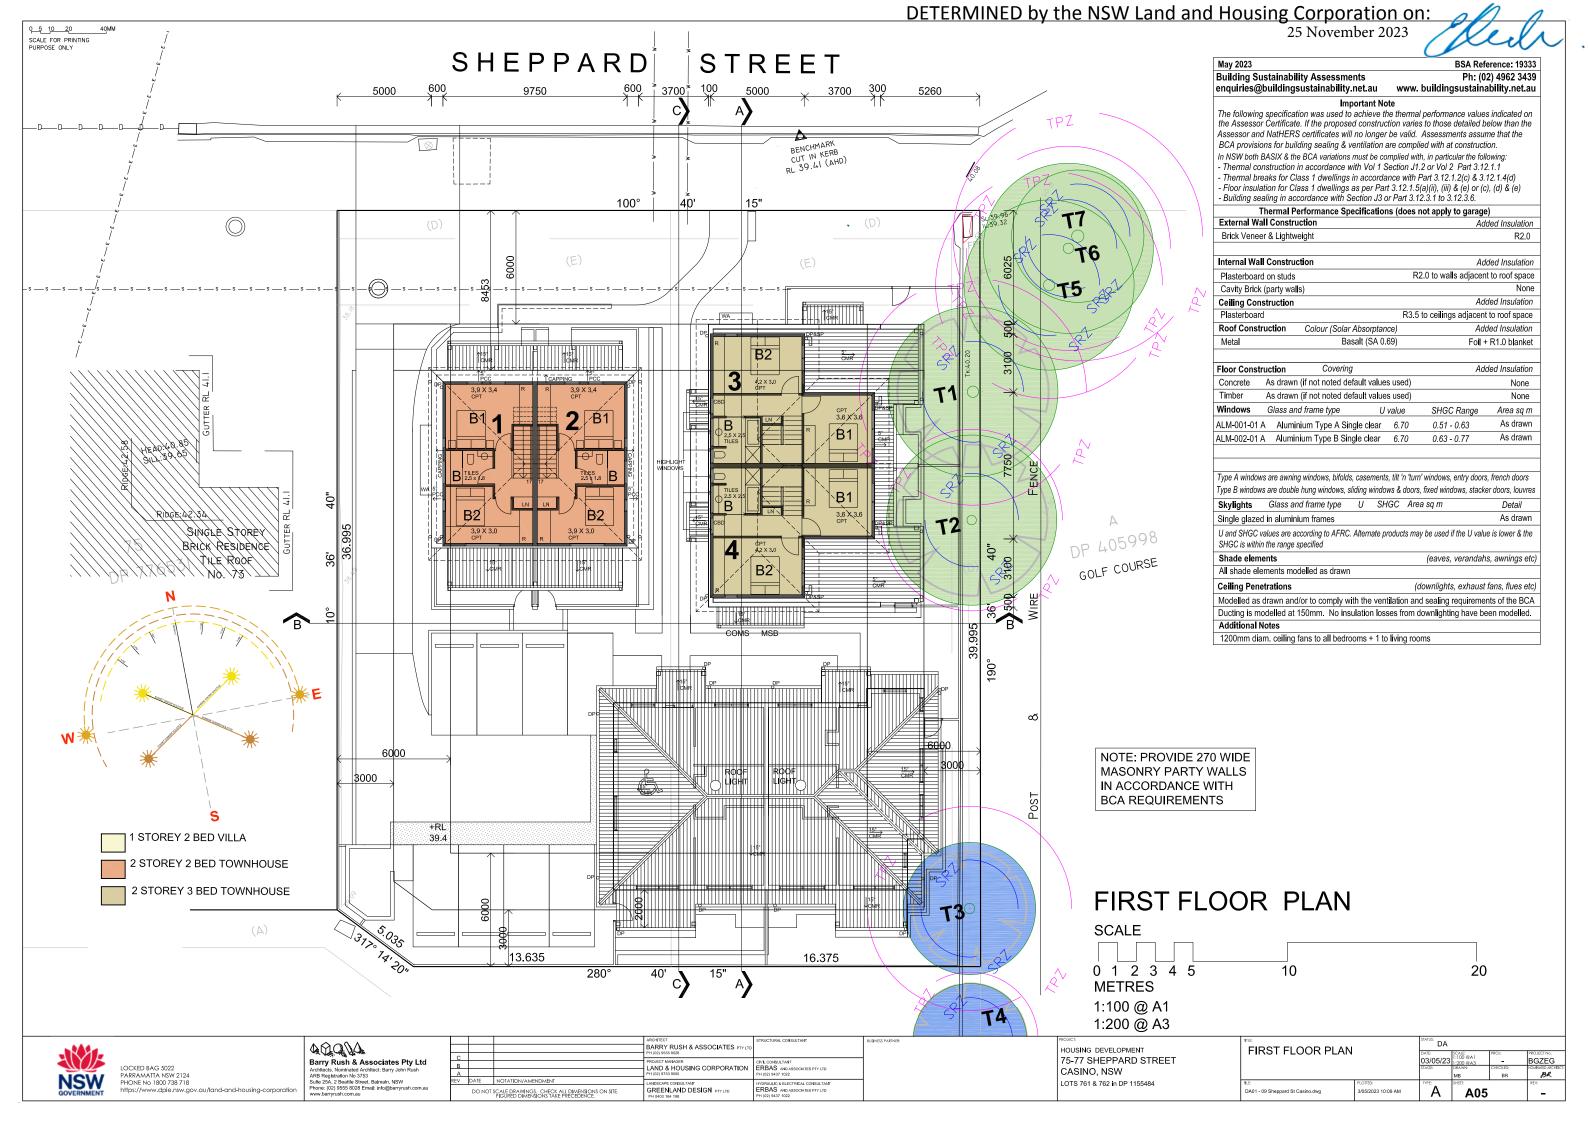

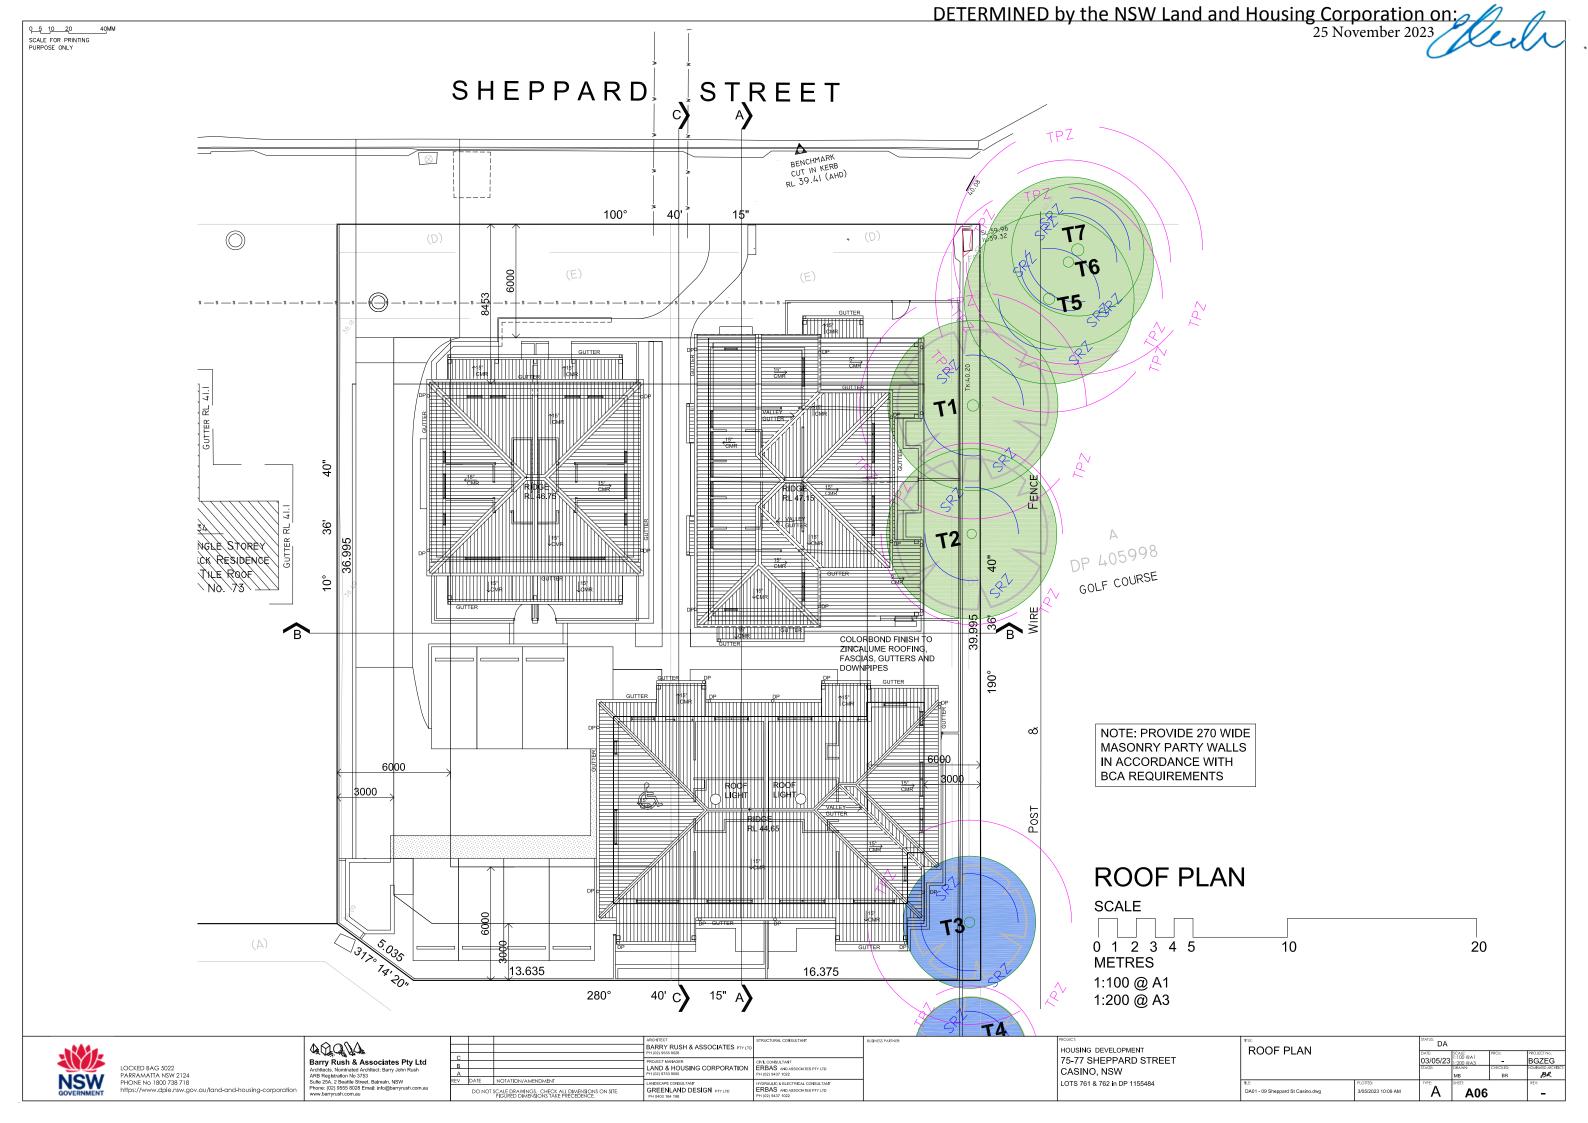

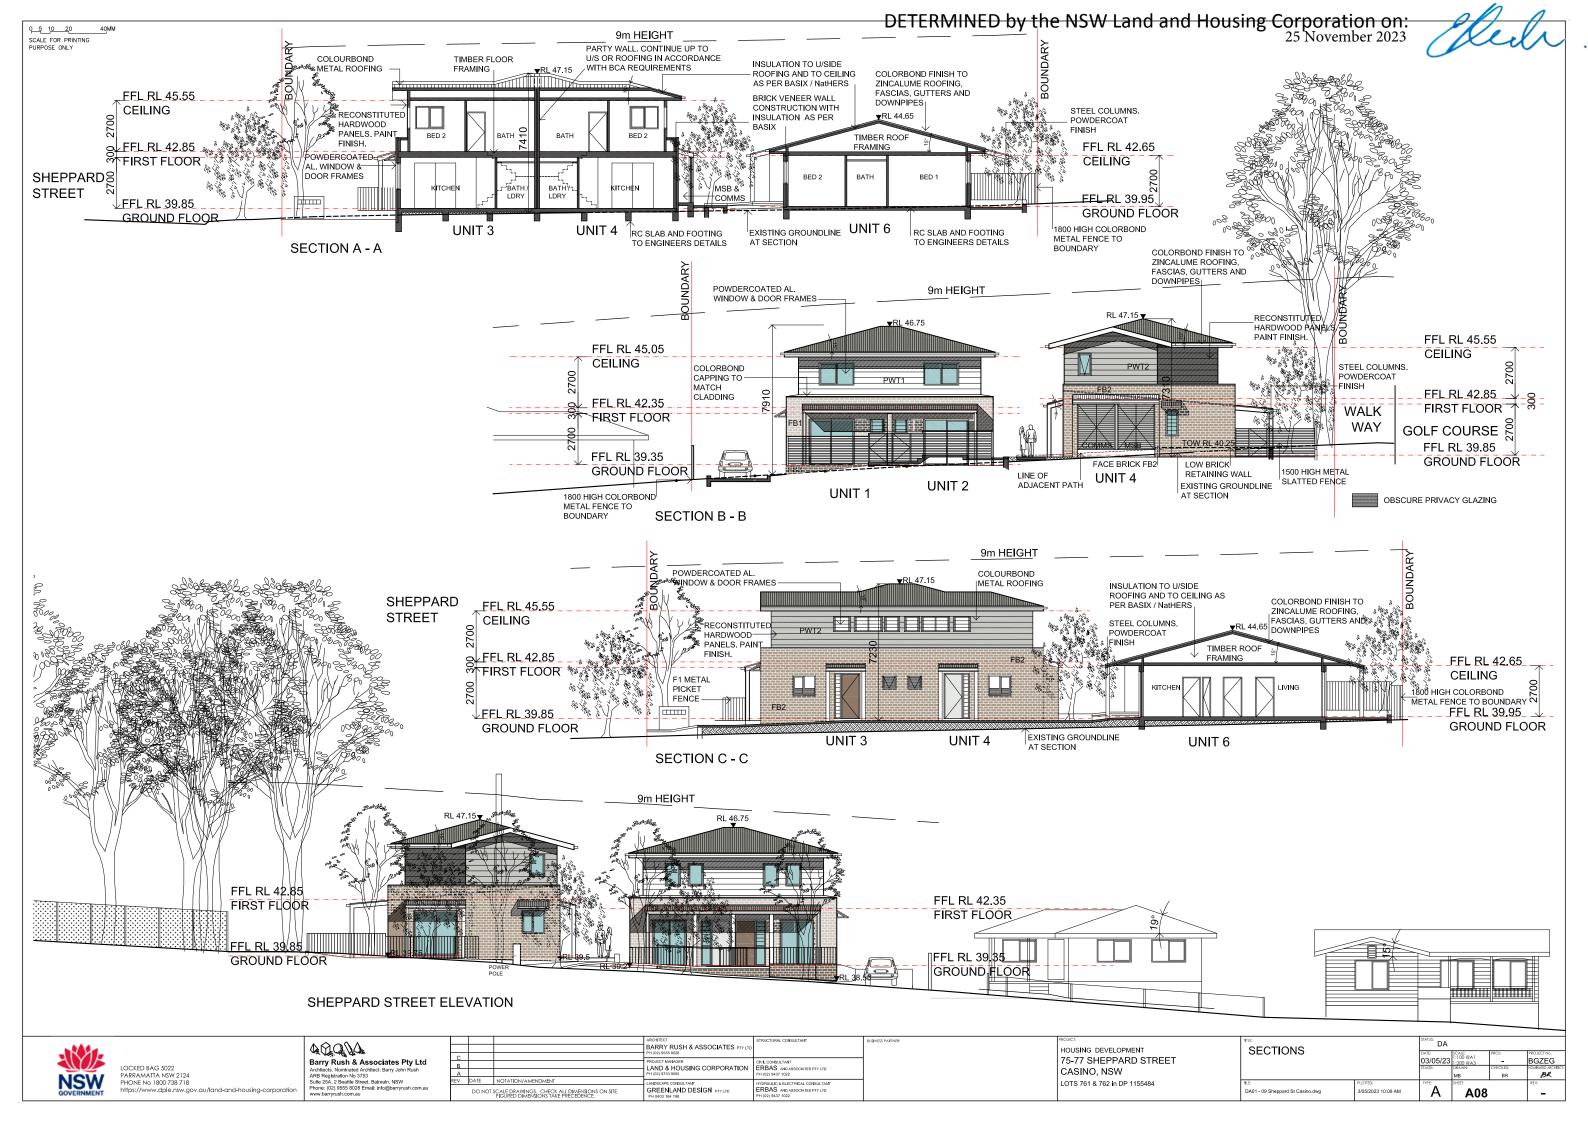

25 November 2023





FINISHES SCHEDULE

CODE	LOCATION	DESCRIPTION	COLOUR
CMR	ROOFING/	CORRUGATED COLORBOND METAL ROOFING	BASALT
CM1	FASCIA, GUTTER, AWNING, COLUMNS & BEAMS	METAL COLORBOND & GALV STEEL	WINDSPRAY
FB1	WALLS UNITS 1 & 2	FACE BRICK light warm	PGH BRICK VELOUR "CRUSHED GREY"
FB2	WALLS UNITS 3, 4, 5 & 6	FACE BRICK light off white	PGH BRICK VELOUR "MINERAL"
FB3	SITE WALLS & BIN STORAGE	FACE BRICK medium warm	PGH BRICK OPALINE "TOURMALINE"
PR1	LETTERBOX WALL	PAINTED RENDER	DULUX LEXICON HALF
FC1	EAVES LINING & SOFFIT	PAINTED FIBER CEMENT SHEETING	DULUX LEXICON HALF

CODE	LOCATION	DESCRIPTION	COLOUR
PWT1	FIRST FLOOR WALLS UNITS 1&2	RECONSTITUTED HARDWOOD PLANKS -PRE SEALED. PAINT FINISH	WATTYL "WINTER SKY"
PWT2	FIRST FLOOR WALLS UNITS 3&4	RECONSTITUTED HARDWOOD PLANKS -PRE SEALED. PAINT FINISH	WATTYL "SEQUOIA DUSK"
W & D	WINDOWS & GLASS DOORS FRAMING	POWEDERCOATED ALUMNIUM	WHITE
PS	PRIVACY SCREEN	ALUMINIUM HORIZONTAL SLATTED BARS	SURFMIST
F1	METAL FENCES TO FRONT POS	POWDERCOATED METAL	DULUX WINDSPRAY
F2	FENCE	1800 HIGH COLORBOND METAL FENCE	DULUX WINDSPRAY
F3	SLATTED METAL FENCES TO REAR POS	1500 HIGH (UNLESS NOTED OTHERWISE) SLATTED POWDERCOATED METAL FENCE	DULUX WINDSPRAY
D1	FRONT DOOR UNITS 1, 3, 5	PAINT FINISH TO ENTRY DOOR	DULUX "TERRAIN"
D2	FRONT DOOR UNITS 2, 4, 6	PAINT FINISH TO ENTRY DOOR	DULUX "LEXICON HALF"

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www.barryrush.com.au

				ARCHITECT BARRY RUSH & ASSOCIATES PTYLTD PH (02) 9655 8028	STRUCTURAL CONSULTANT
Е	B A			PROJECT MANAGER LAND & HOUSING CORPORATION PH (02) 8763 9000	CIVIL CONSULTANT ERBAS AND ASSOCIATES PTY LTD PH (02) 9437 1022
RE	V	DATE DO NOT :	NOTATION/AMENDMENT SCALE DRAWINGS, CHECK ALL DIMENSIONS ON SITE. FIGURED DIMENSIONS TAKE PRECEDENCE.	CANDSCAPE CONSULTANT GREENLAND DESIGN PTYLTD PH 0403 164 198	HYDRAULIC & ELECTRICAL CONSULTANT ERBAS AND ASSOCIATES PTY LTD PH (02) 9437 1022





EXISTING 1 STOREY TOWNHOUSE DEVELOPMENT 46 - 60 SHEPPARD ST




EXISTING 1 STOREY DUAL OCCUPANCY 66 SHEPPARD ST




EXISTING 1 STOREY TOWNHOUSE DEVELOPMENT



EXISTING 1 STOREY TOWNHOUSE DEVELOPMENT 9 LAUREL ST

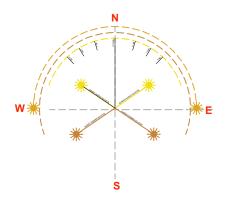

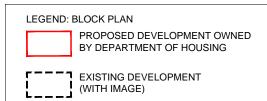



PROPOSED 2 STOREY TOWNHOUSE DEVELOPMENT 75 - 77 SHEPPARD ST



1 WILLOW PLACE

EXISTING 1 STOREY TOWNHOUSE DEVELOPMENT 1 WILLOW PLACE



EXISTING 1 STOREY VILLA DEVELOPMENT 26 TALLOWOOD AVE



EXISTING 1 STOREY DUAL OCCUPANCY 2 FAIRWAY DRV



EXISTING 1 STOREY DUAL OCCUPANCY 59 SHEPPARD ST



LOCKED BAG 5022 PARRAMATIA NSW 2124 PHONE No. 1800 738 718 https://www.dpie.nsw.gov.au/land-and-housing-corporation

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nain, NSW nfo@barryrush.com.au	R

			ARCHITECT BARRY RUSH & ASSOCIATES PTY LTD PH (02) 9555 8028	STRUCTURAL CONSULTANT
			PROJECT MANAGER LAND & HOUSING CORPORATION PH (02) 8753 9000	CIVIL CONSULTANT ERBAS AND ASSOCIATES PTY LTD PH (02) 9437 1022
,	DATE	NOTATION/AMENDMENT	LANDSCAPE CONSULTANT	HYDRAULIC & ELECTRICAL CONSULTANT
DO NOT SCALE DRAWINGS. CHECK ALL DIMENSIONS ON SITE. FIGURED DIMENSIONS TAKE PRECEDENCE.		CALE DRAWINGS. CHECK ALL DIMENSIONS ON SITE. FIGURED DIMENSIONS TAKE PRECEDENCE.	GREENLAND DESIGN PTY LTD PH 0403 164 198	ERBAS AND ASSOCIATES PTY LTD PH (02) 9437 1022

HOUSING DEVELOPMENT
75-77 SHEPPARD STREET
75-77 SHEPPARD STREET CASINO, NSW
LOTS 761 & 762 in DP 1155484

TITLE:		STATUS: DA			
BLOCK ANALYSIS P	LAN	DATE:	SCALE:	PROJ:	PROJECT No.
		03/05/23	NTS		BGZEG
		STAGE:	DRAWN:	CHECKED:	NOMINATED ARCHIT
			LP	BR	BR
FILE:	PLOTTED:	TYPE:	SHEET:		REV:
DA10 - DA14 Sheppard St Casino.dwg	3/05/2023 10:12 AM	A	A10		-


25 November 2023




9AM 21ST JUNE




10AM 21ST JUNE

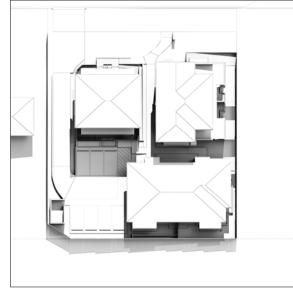


11AM 21ST JUNE

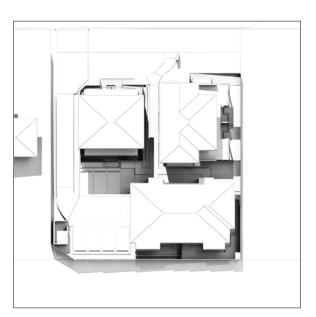


12NOON 21ST JUNE

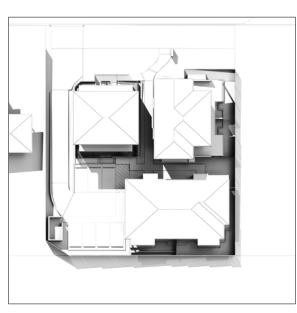

1PM 21ST JUNE

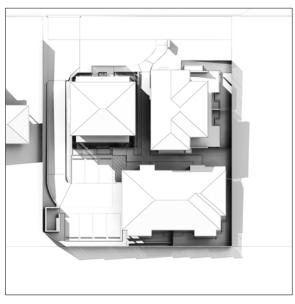

2PM 21ST JUNE

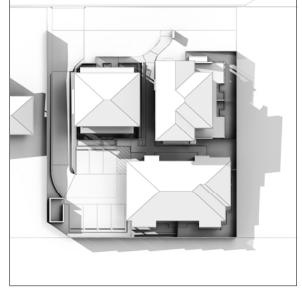



LEGEND: Grey area indicates shadows cast by proposed development

3PM 21ST JUNE




	400M
	Barry Rush & Associates Pty Ltd
	Architects, Nominated Architect; Barry John Rush
	ARB Registration No 3753
	Sulte 25A, 2 Beattle Street, Balmain, NSW
,	Phone: (02) 9555 8028 Email: info@barryrush.com.au
	www.barryrush.com.au

			ARCHITECT	STRUCTURAL CONSULTANT
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_			PH (02) 9555 8028	
В			PROJECT MANAGER LAND & HOUSING CORPORATION	CML CONSULTANT ERBAS AND ASSOCIATES PTYLTD
Α			PH (02) 8753 9000	PH (02) 9437 1022
REV	DATE	NOTATION/AMENDMENT	LANDSCAPE CONSULTANT	HYDRAULIC & ELECTRICAL CONSULTANT
	DO NOT	CALE DRAWINGS. CHECK ALL DIMENSIONS ON SITE. FIGURED DIMENSIONS TAKE PRECEDENCE.		ERBAS AND ASSOCIATES PTY LTD PH (02) 9437 1022


HOUSING DEVELOPMENT
75-77 SHEPPARD STREET
HOUSING DEVELOPMENT 75-77 SHEPPARD STREET CASINO, NSW
LOTS 761 & 762 in DP 1155484

CHADOM DIACDAI	STATUS: DA					
SHADOW DIAGRAMS - MID WINTER			SCALE:	PROJ:	PROJECT No.	
			NTS	l -	BGZEG	
I MID WINTER		STAGE:	DRAWN:	CHECKED:	NOMINATED ARCHITECT:	
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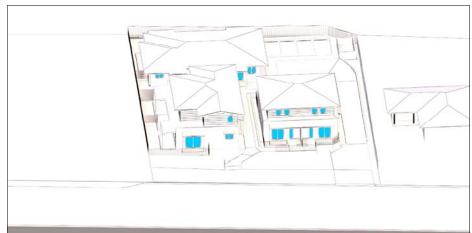
25 November 2023

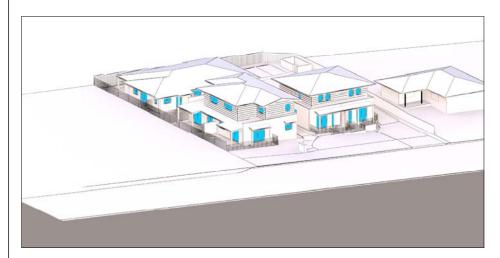

9AM 21ST JUNE

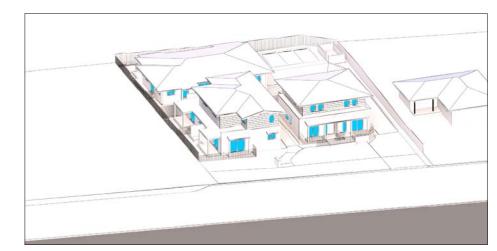


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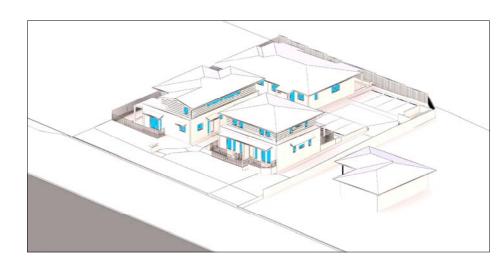
11AM 21ST JUNE




12NOON 21ST JUNE



1PM 21ST JUNE

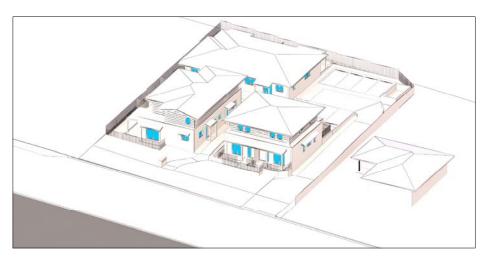

2PM 21ST JUNE

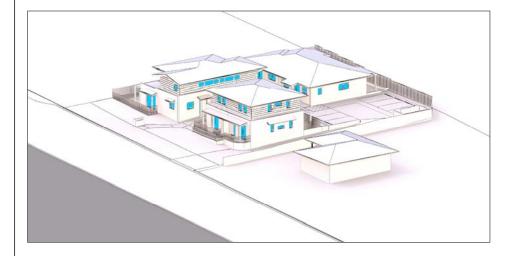

3PM 21ST JUNE



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REV	DATE	NOTATION/AMENDMENT	LANDSCAPE CONSULTANT	HYDRAULIC & ELECTRICAL CONSULTANT	
	DO NOT :	SCALE DRAWINGS. CHECK ALL DIMENSIONS ON SITE. FIGURED DIMENSIONS TAKE PRECEDENCE.		ERBAS AND ASSOCIATES PTY LTD PH (02) 9437 1022	

HOUSING DEVELOPMENT
75-77 SHEPPARD STREET
CASINO, NSW LOTS 761 & 762 in DP 1155484

VIEWS EDOM SHINE	STATUS: DA					
VIEWS FROM SUN DIAGRAM			SCALE:	PROJ:	PROJECT No.	
		03/05/23			BGZEG	
		STAGE:	DRAWN:	CHECKED:	NOMINATED ARCHITECT:	
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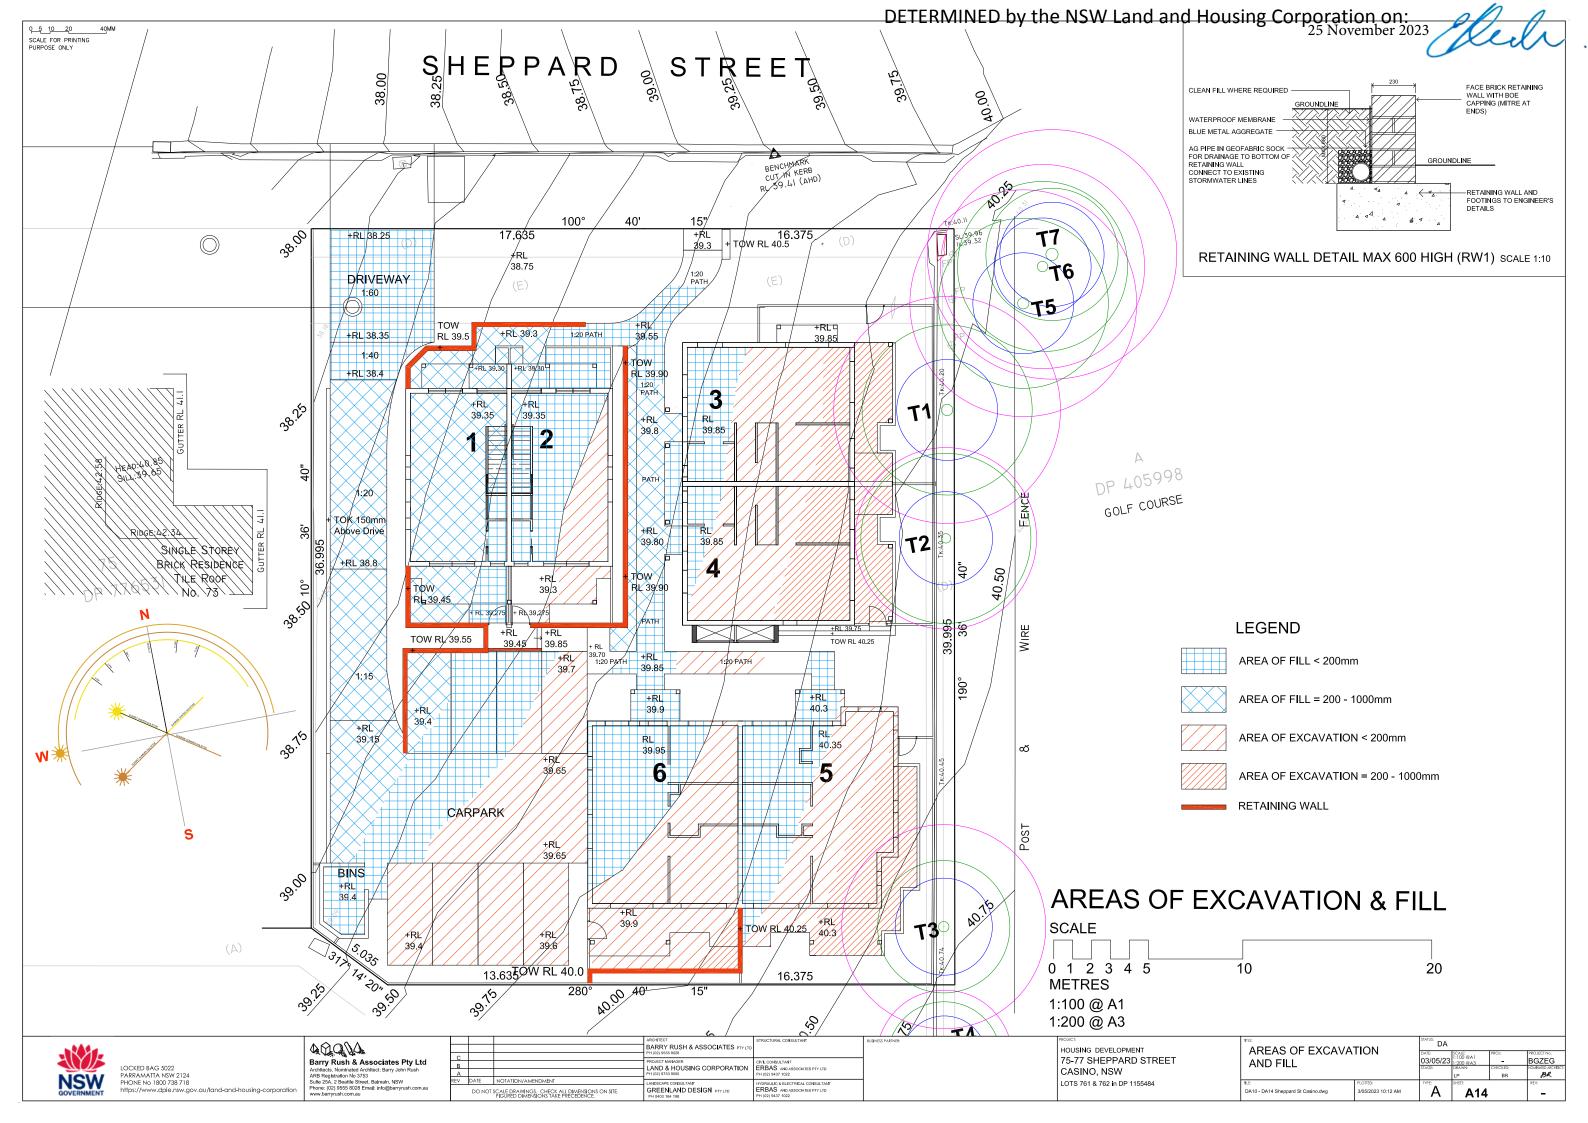



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Arblacts. Normhated Architect: Barry John Rush
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Sulte 25A, 2 Seattle Street, Bellmain, NSW
Phone: (02) 9555 9028 Email: infe@barryrush.com.au

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B A			PROJECT MANAGER LAND & HOUSING CORPORATION PH (02) 8753 9000	CIVIL CONSULTANT ERBAS AND ASSOCIATES PTY LTD PH (02) 9437 1022	
EV	DATE	NOTATION/AMENDMENT	LANDSCAPE CONSULTANT	HYDRAULIC & FLECTRICAL CONSULTANT	
DO NOT SCALE DRAWINGS. CHECK ALL DIMENSIONS ON SITE, FIGURED DIMENSIONS TAKE PRECEDENCE.				ERBAS AND ASSOCIATES PTY LTD PH (02) 9437 1022	


HOUSING DEVELOPMENT
75-77 SHEPPARD STREET
CASINO, NSW
LOTS 761 & 762 in DP 1155484

STREET PERSPEC	TI\/E	STATUS: DA					
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DA10 - DA14 Sheppard St Casino.dwg	3/05/2023 10:12 AM	A	A13	;	-		



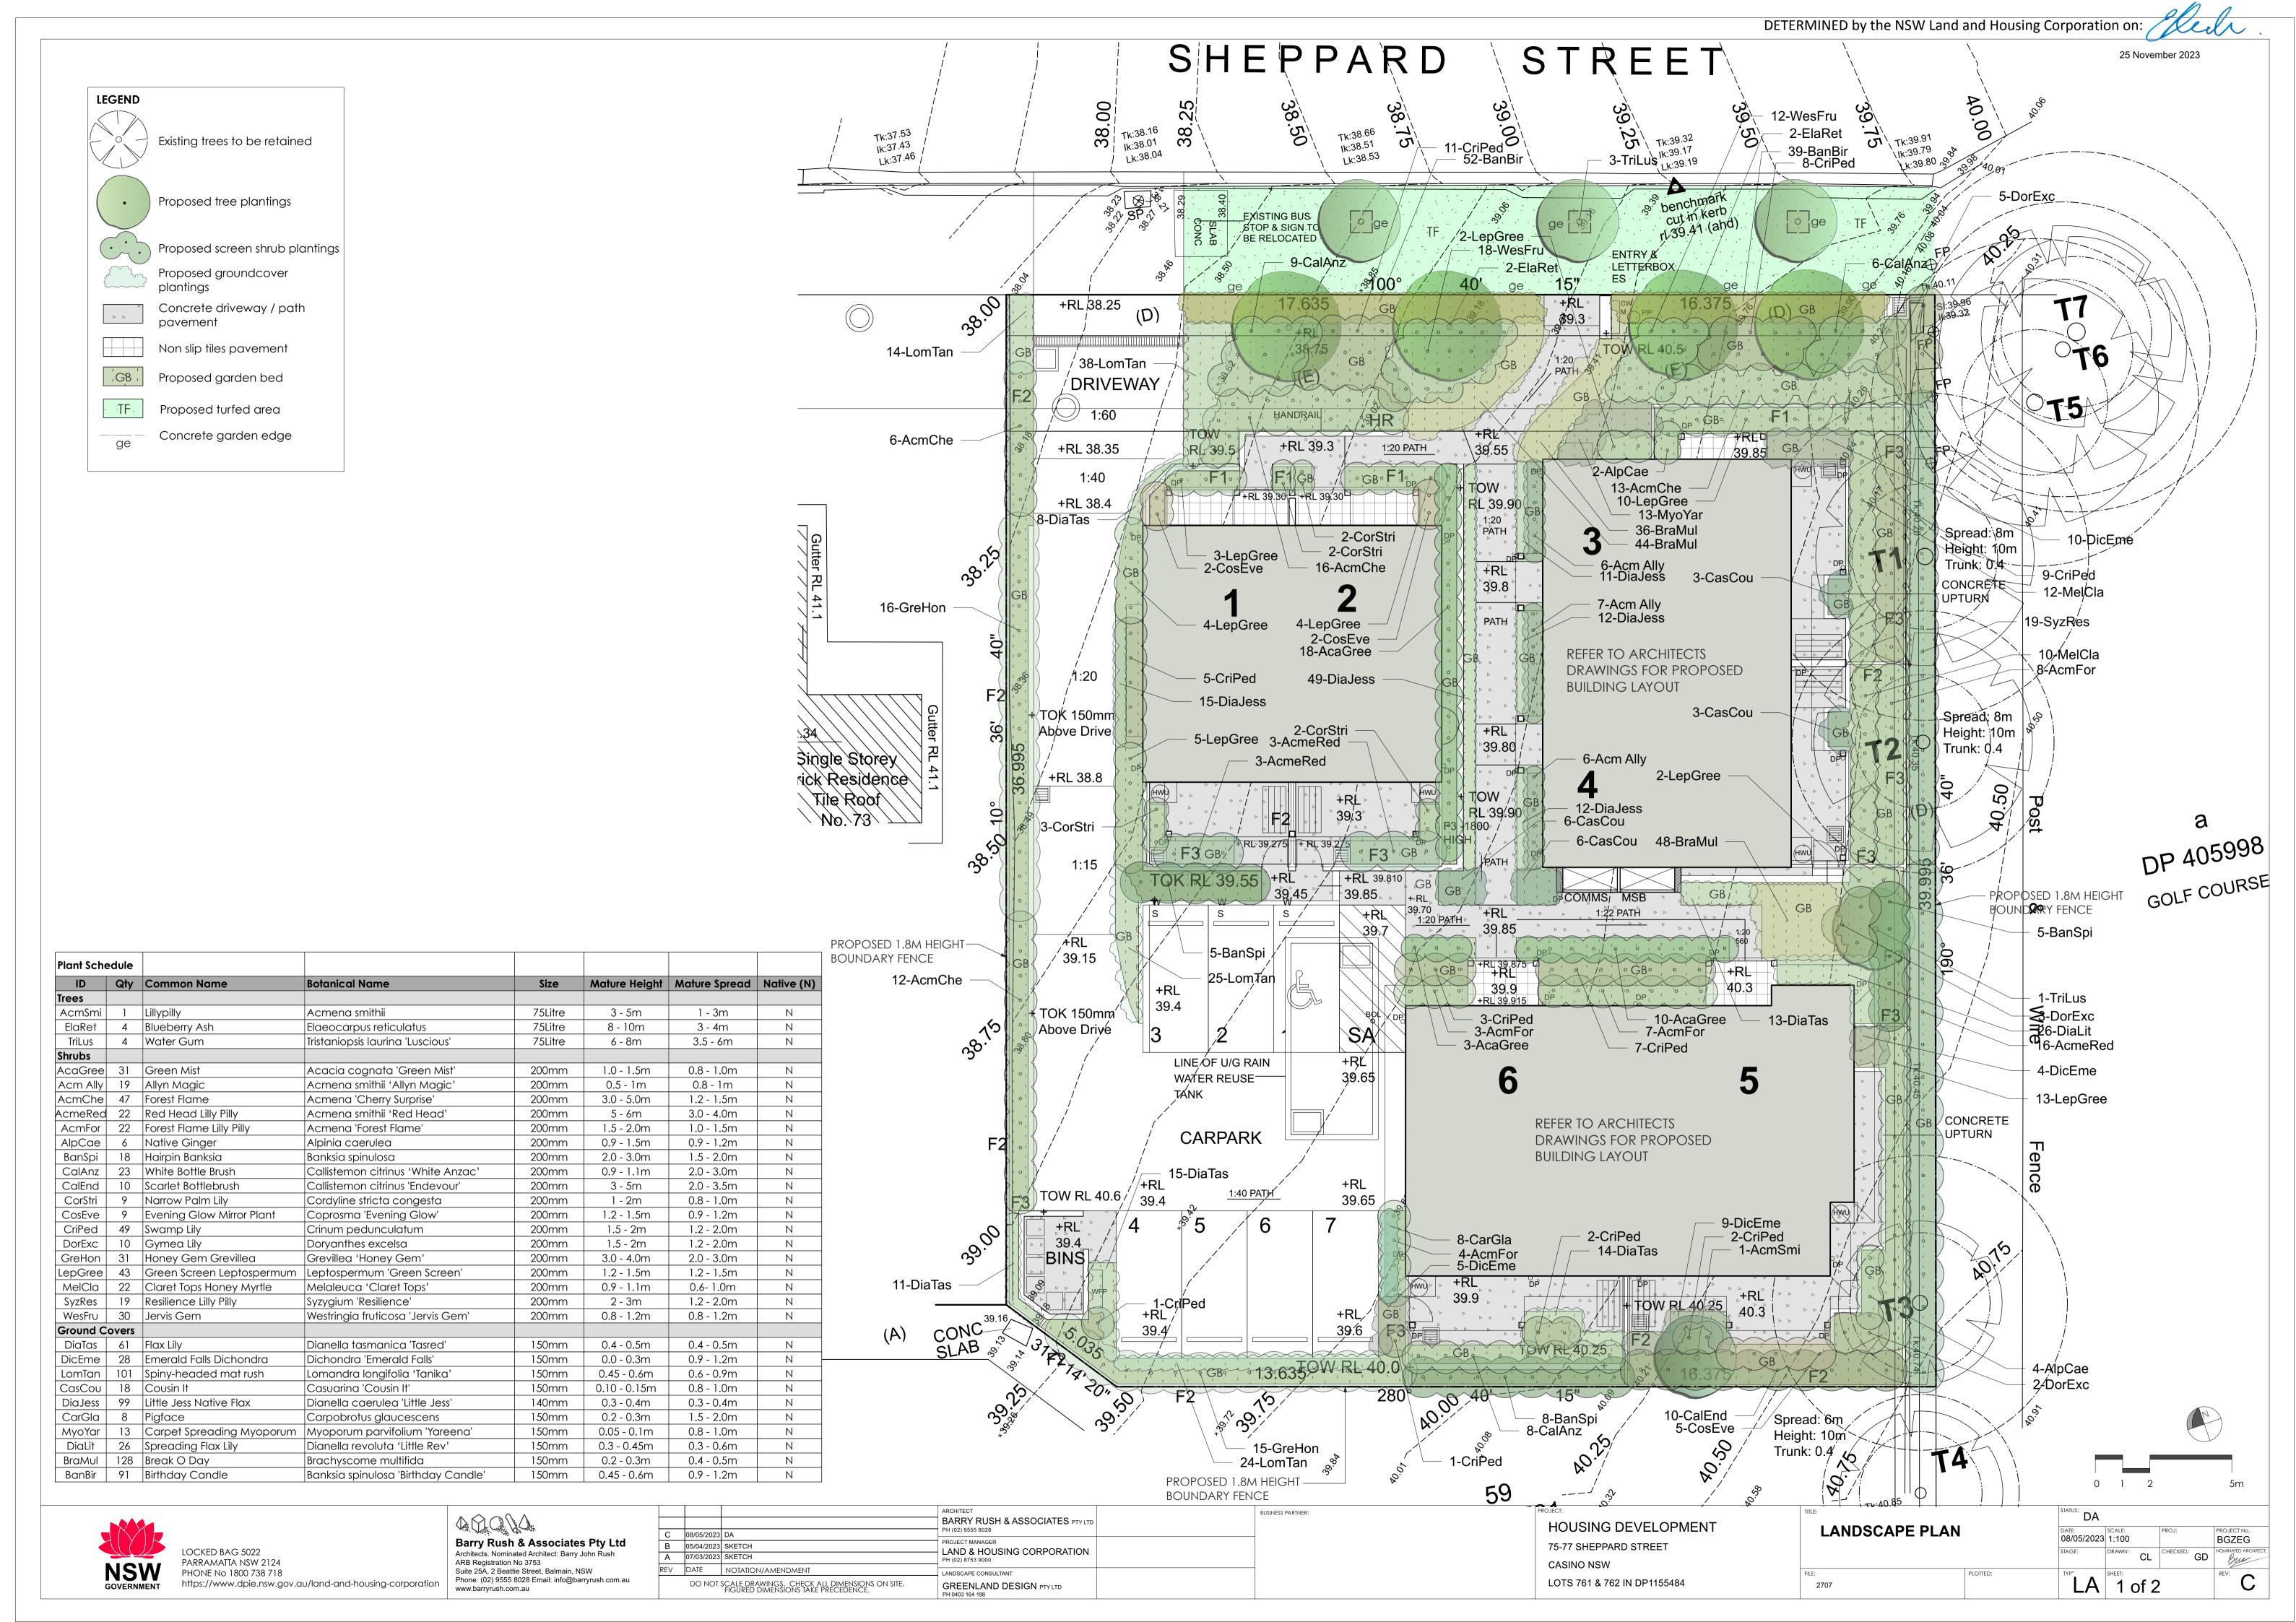



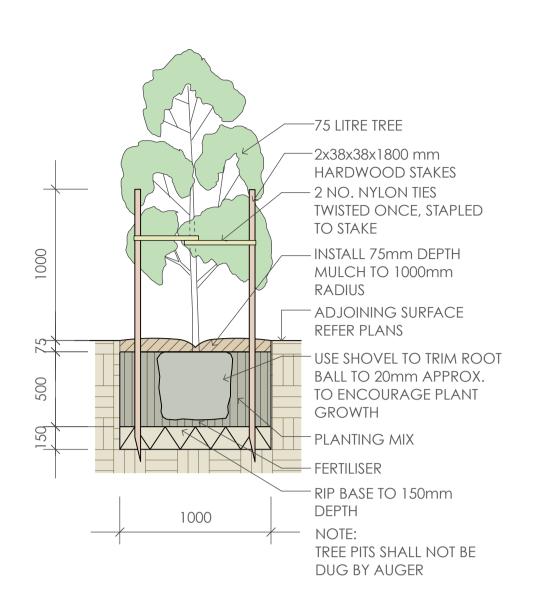

scale 1:25

75 Litre Tree Planting

SPECIFICATION NOTES PLANTING MATERIALS

Planting mix for tree pit backfill shall be "Organic Garden Mix" consisting of

- 50% Black Soil
- 20% Coarse Sand 30% Organic Material

as available from Australian Native Landscapes, Phone: [02] 9450 1444, or approved equivalent. Samples shall be provided to the Superintendent prior to ordering or delivery to site. Any material delivered to site, that is rejected by the Superintendent, shall be removed by the contractor at his own expense. Minimum depths of mix to all planting bed areas is as specified on details.

Mulch: Mulch to garden bed:

Mulch shall mean hardwood mulch (25mm grade), free from material derived from Privet, Willow, Poplar, Coral trees, or other noxious weeds. Any mulch exceeding the 25mm grade shall be rejected / removed from the site. Graded hardwood mulch to be supplied by Australian Native Landscapes Pty Ltd Phone (02) 9450 1444, or approved equivalent.

Spread mulch so that after settling, it is:

- smooth and evenly graded between design surface levels;
- flush with adjacent finished levels;

placed and levelled prior to turfing.

- of the required depths (75mm); and
- sloped towards the base of plant stems in plantation beds, but not in contact with the stem (not closer than 50mm in the case of gravel mulches).


Place after the preparation of the planting bed, planting and all other work. Plant Material:

All plant material must be true to the species. No substitutes will be allowed. All plants shall be free of fungus and insect damage. All plants shall be healthy, well shaped, not soft or force grown and not root bound.


Plants are available from **Andreasens Green** wholesale nursery, contact Darren (02) 8777 4713, email darren@andreasensgreen.com.au or approved equivalent. Turfed areas:

All new turfed areas are to be selected weed free Soft Leaf Buffalo. Turf shall be laid neatly butted with staggered joins, flush with adjacent surfaces and have even

running falls to all drainage points. All new turfed area shall have a minimum 150mm depth of weed free top soil,

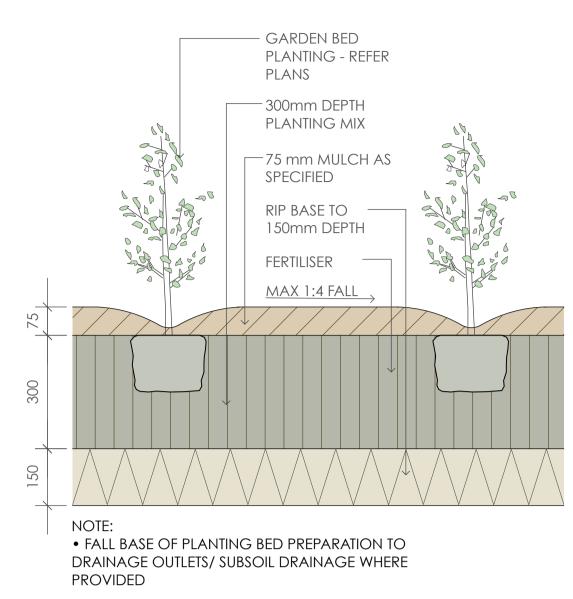

Planting Bed Detail scale 1:10

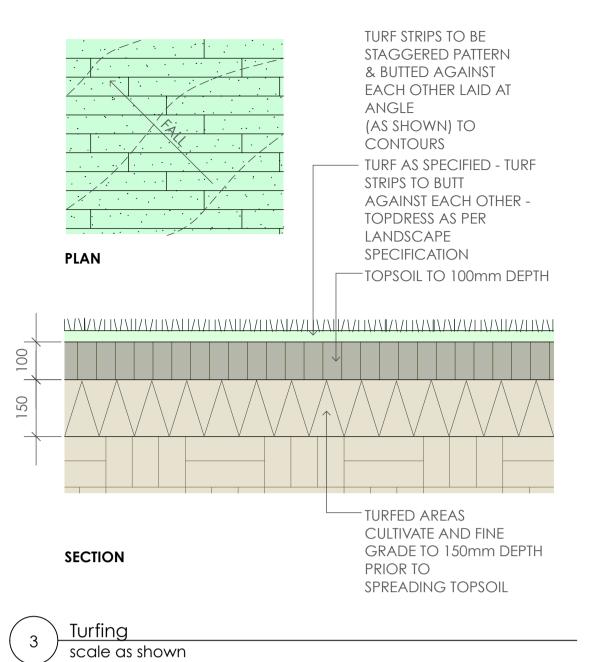

CHAMFER TOP (EXPOSED) CORNERS 10mm FLUSH CONCRETE EDGE — ADJOINING SURFACE $^{oldsymbol{ o}}$ N 12 CENTRALLY LOCATED **SECTION**

Concrete Edge

PREPARATION AND HARDWORKS

Excavating for Spot Planting

To planting areas, excavate a hole for each plant large enough to provide not less than twice the depth and twice the diameter than the root ball of species to be planted.

Use durable hardwood, straight, free from knots or twists, pointed at one end. Drive stakes into the ground a minimum one third of their length, avoiding damage to the root system.

• 75 Litre trees in 2 x 38x38x1800mm Hardwood Stake with double Nylon tie TIES: Provide a 50mm wide Nylon webbing tie per stake, fixed securely to the stakes, one tie at half the height of the main stem and the other as necessary to stabilise the

Concrete Edge

MATERIALS: Concrete to be off white colour.

INSTALLATION: Supply and install 150 x 100mm (width) reinforced flush concrete kerb to locations as approved on site by the Superintendent. Provide flexible joints at maximum 3 metre intervals in colour to match concrete. Lightly expose aggregate through rinsing / sponging. Tool finish exposed edges with 10mm pencil round to prevent chipping.

MAINTENANCE / PLANT ESTABLISHMENT

Maintenance shall apply to all hard and soft landscape materials installed prior to the "handover" and acceptance by Principles Representative and the Site Superintendent. The maintenance period shall convenience at the granting of practical completion and shall extend for 12 months.

Maintenance shall consist of the following works:

- Follow a daily watering programme to be approved by Superintendent. Water all plants individually, twice per week or when necessary to ensure constant plant

- Apply appropriate weed control sprays and hand weed as required to maintain planting areas, native grassing bed areas, paved areas, and tree pits in turf free of weed or rogue grass growth.

- Regularly tidy and top up mulch and trim edges to prevent spill over onto paved /

- Spray to control pests and diseases.

- Replace plants, which fail with plants of a similar size and quality as originally specified to approval of Superintendent. Costs of replacement shall be the responsibility of the Contractor. Replacement planting will be undertaken within 2 weeks of identification of dead material or instruction be the Superintendent.

- Report any incidence of plants stolen or destroyed by vandalism. - Adjust stakes and ties to plants as necessary. Ensure that strangulation of plants

does not occur.

- Prune and shape plants as directed or where necessary.

- Make good any defects or faults arising out of defective workmanship or materials. - Make good any erosion or soil subsidence, which may occur including soft areas in pathways.

- A final inspection shall be made by the Superintendent before handover. Any items requiring rectification shall be repaired before the works are finally approved, and retention moneys released.

NOTE:

- All finished levels are to be verified by Contractor on site.

- All landscape works be in strict accordance with Council's landscape code and

- This plan to be used in conjunction with all other submitted architectural, hydraulics and engineering drawing where applicable.

GREENLAND DESIGN												
TWELVE MONTHS MAINTENANCE SCHEDULE	Jan	Feb	Mar	Apr	May	Jun	Jul	Aug	Sep	Oct	Nov	Dec
Plant Care												
Monitoring												
Pruning as required												
Deadhead /tip pruning												
Slow release fertilise												
Rapid suluble fertilise as required												
Cut back perenials and grasses												
Watering as required												
Garden Bed												
Edging												
Remove weeds and herbicide spraying as required												
Top up mulch as required												
Dead foliage removal												
Pest Management												
Monitoring and herbicide spraying as required												
Turfed Area												
Fertilise												
Make good turf as required												
Winter clean up												
Remove dead foliage and pruning as required												







PROJECT:	TITLE:				
HOUSING DEVELOPMENT	LANDSCAPE DETAILS AND				
75-77 SHEPPARD STREET	SPECIFICATION				
CASINO NSW					
LOTS 761 & 762 IN DP1155484	FILE: 2707	PLOTTED:			



75-77 SHEPPARD STREET, CASINO STORMWATER SERVICES

LEGEND


ABBREVIATIONS

AEP ANNUAL EXCEEDANCE PROBABILITY
ARI AVERAGE RECURRENCE INTERVAL
CO CLEAROUT
Ø DIAMETER
DP DOWNPIPE
DWG DRAWING
e EXISTING
GTD GRATED TRENCH DRAIN
IL INVERT LEVEL
kPa KILOPASCALS
L LITRES
L/s LITRES
L/s LITRES PER SECOND
m METRES
m2 SQUARE METRES
m3 CUBIC METRES
m/s METRES PER SECOND
mm MILLIMETRES

NOMINAL
DF OVERFLOW
VC UNPLASTICIZED POLYVINYL CHLORIDE
Q100 QUANTITY OF FLOW FOR 100 YEAR ARI STORM
Q20 QUANTITY OF FLOW FOR 20 YEAR ARI STORM
VL REDUCED LEVEL
AC SEWER ACCESS CHAMBER
WP STORMWATER PIT

UNLESS NOTED OTHERWISE

PIPE SERVICES

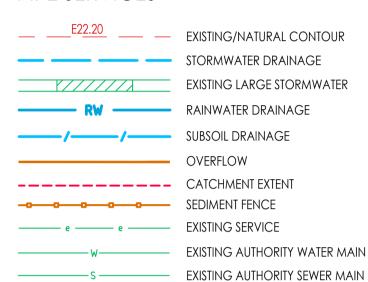


SYMBOLS

PENETRATING PIPE NON-PENETRATING PIPE PENETRATING OFFSET NON-PENETRATING OFFSET PENETRATING TEE DROPPER NON-PENETRATING TEE DROPPER CAPPED SERVICE OPEN ENDED PIPE CONNECT TO EXISTING PIPE SERVICE CONNECTION STREET HYDRANT PUMP CONTROL SURFACE FLOW DIRECTION SURFACE GRADING TO DIRECT FLOW PIPE NETWORK NODE CLEAR OUT RAINWATER OUTLET GRATED TRENCH DRAIN

DI DETAIL DETAIL NUMBER & DESCRIPTION

DRAWING REFERENCE & SCALE

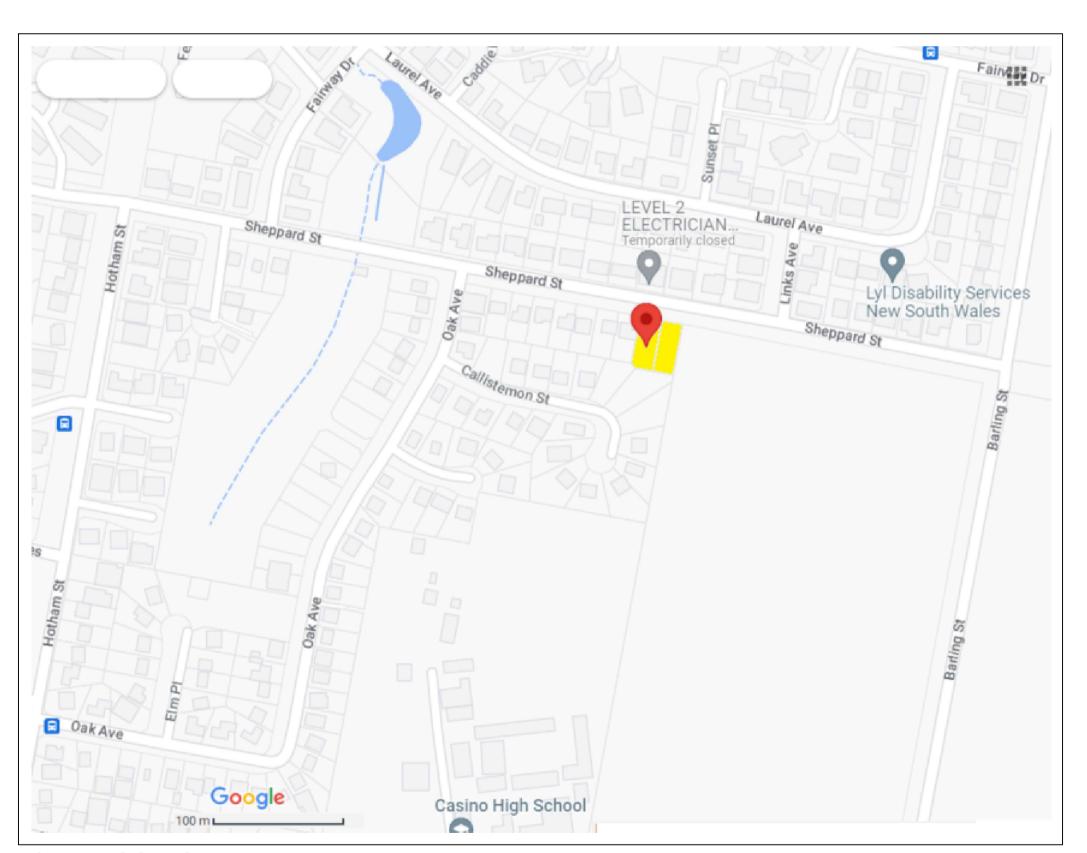

SCHEDULE OF DRAWINGS						
DRAWING No.	DRAWING TITLE					
SYD23062-SW000	COVER SHEET, LEGEND & DRAWING SCHEDULE					
SYD23062-SW001	erosion & Sediment Control Plan					
SYD23062-SW101	GROUND FLOOR PLAN					
SYD23062-SW102	FIRST FLOOR PLAN					
SYD23062-SW103	ROOF PLAN					
SYD23062-SW201	DETAIL SHEET 1					
SYD23062-SW202	DETAIL SHEET 2					

	IMPORTANT - FOR PRINCI	PAL CO	NTRACTO)R		
LEGISI ALL ST	ABLE THE ISSUE OF STORMWATER CERTIFICATION PERM LATION, SITE INSPECTIONS MUST OCCUR. THE PRINCIPA ORMWATER INSPECTIONS. ABSENCE OF INSPECTION W ISPECTIONS ARE TO BE COMPLETED BY ERBAS AS FOLLO	L CONTRAC /ILL PREVEN	CTOR IS RESP	ONSIBLE FOR	COORDIN	IATING
INSPECTION	STORMWATER INSPECTION REQUIREMENTS	ERBAS REPRESENTATIVE		INSPECTION	PASS	FAIL
NO.		NAME	SIGNATURE	DATE	TICK 🗸	OR N/A
1	INSPECTION OF INGROUND STORMWATER DRAINAGE PRIOR TO BACKFILL (MANDATORY)					
2	INSPECTION OF ANY INGROUND STORMWATER DRAINAGE NOT VIEWED AT INSPECTION NO. 1 (OPTIONAL)					
3	INSPECTION OF INFILTRATION PIT / TANK / TRENCH PRIOR TO BACKFILL (JOB SPECIFIC)					
4	FINAL INSPECTION ON COMPLETION OF ALL LANDSCAPING & POST COMMISSIONING OF THE STORMWATER SYSTEM (MANDATORY)					
5	SURVEY OF RAINWATER & ONSITE DETENTION TANKS & WORKS AS EXECUTED STORMWATER DRAWINGS (MANDATORY) *TO BE PROVIDED TO ERBAS PRIOR TO INSPECTION					

STREET LOCATION PLAN

THIC DDAWN	IC LIAC DEEN DDEDADED IN CONTINUETION WITH THE FOULOWING DDAWN	NOC.		ISSUE	DATE	AMENDMENT	ARC
THIS DRAWII Discipline ARCH PLAN ARCH RCP STRUCTURAL MECHANICAL ELECTRICAL	IG HAS BEEN PREPARED IN CONJUNCTION WITH THE FOLLOWING DRAWIN Dwg. No. -	NGS: Date -	Revisions	P1 P2	10.02.23 04.05.23	PRELIMINARY ISSUE FOR ARCHITECT'S REVIEW DEVELOPMENT APPLICATION ISSUE	ARC
MAY NOT BE R WITHOUT THE V	ID DETAILS SHOWN ON THESE DRAWINGS ARE APPLICABLE TO THIS PROJECT OF THE PROJECT OF T	R PURPOSE DES.					

Parry Puch 8 /

Barry Rush & Associates Pty Ltd Architects. Nominated Architect: Barry John Rush

Architects. Nominated Architect: Barry John Rush ARB Registration No 3753
Suite 25A, 2 Beattie Street, Balmain, NSW
Phone: (02) 9555 8028 Email: info@barryrush.com.au



BUILDING SERVICES ENGINEER



Ph: (02) 9437 1022 general@erbas.com.au

www.erbas.com.au

DESIGNED

IY

MULTI-DWELLING

HOUSING DEVELOPMENT

75-77 SHEPPARD STREET,


CASINO NSW

(RICHMOND VALLEY COUNCIL)


DRAWING TITLE
STORMWATER SERVICES
COVER SHEET, LEGEND &
DRAWING SCHEDULE

SCALE at A1 PROJECT No. DRAWING No. ISSUE

DATE
FEB 2023
DRAWN SYD23062-SW000 P2

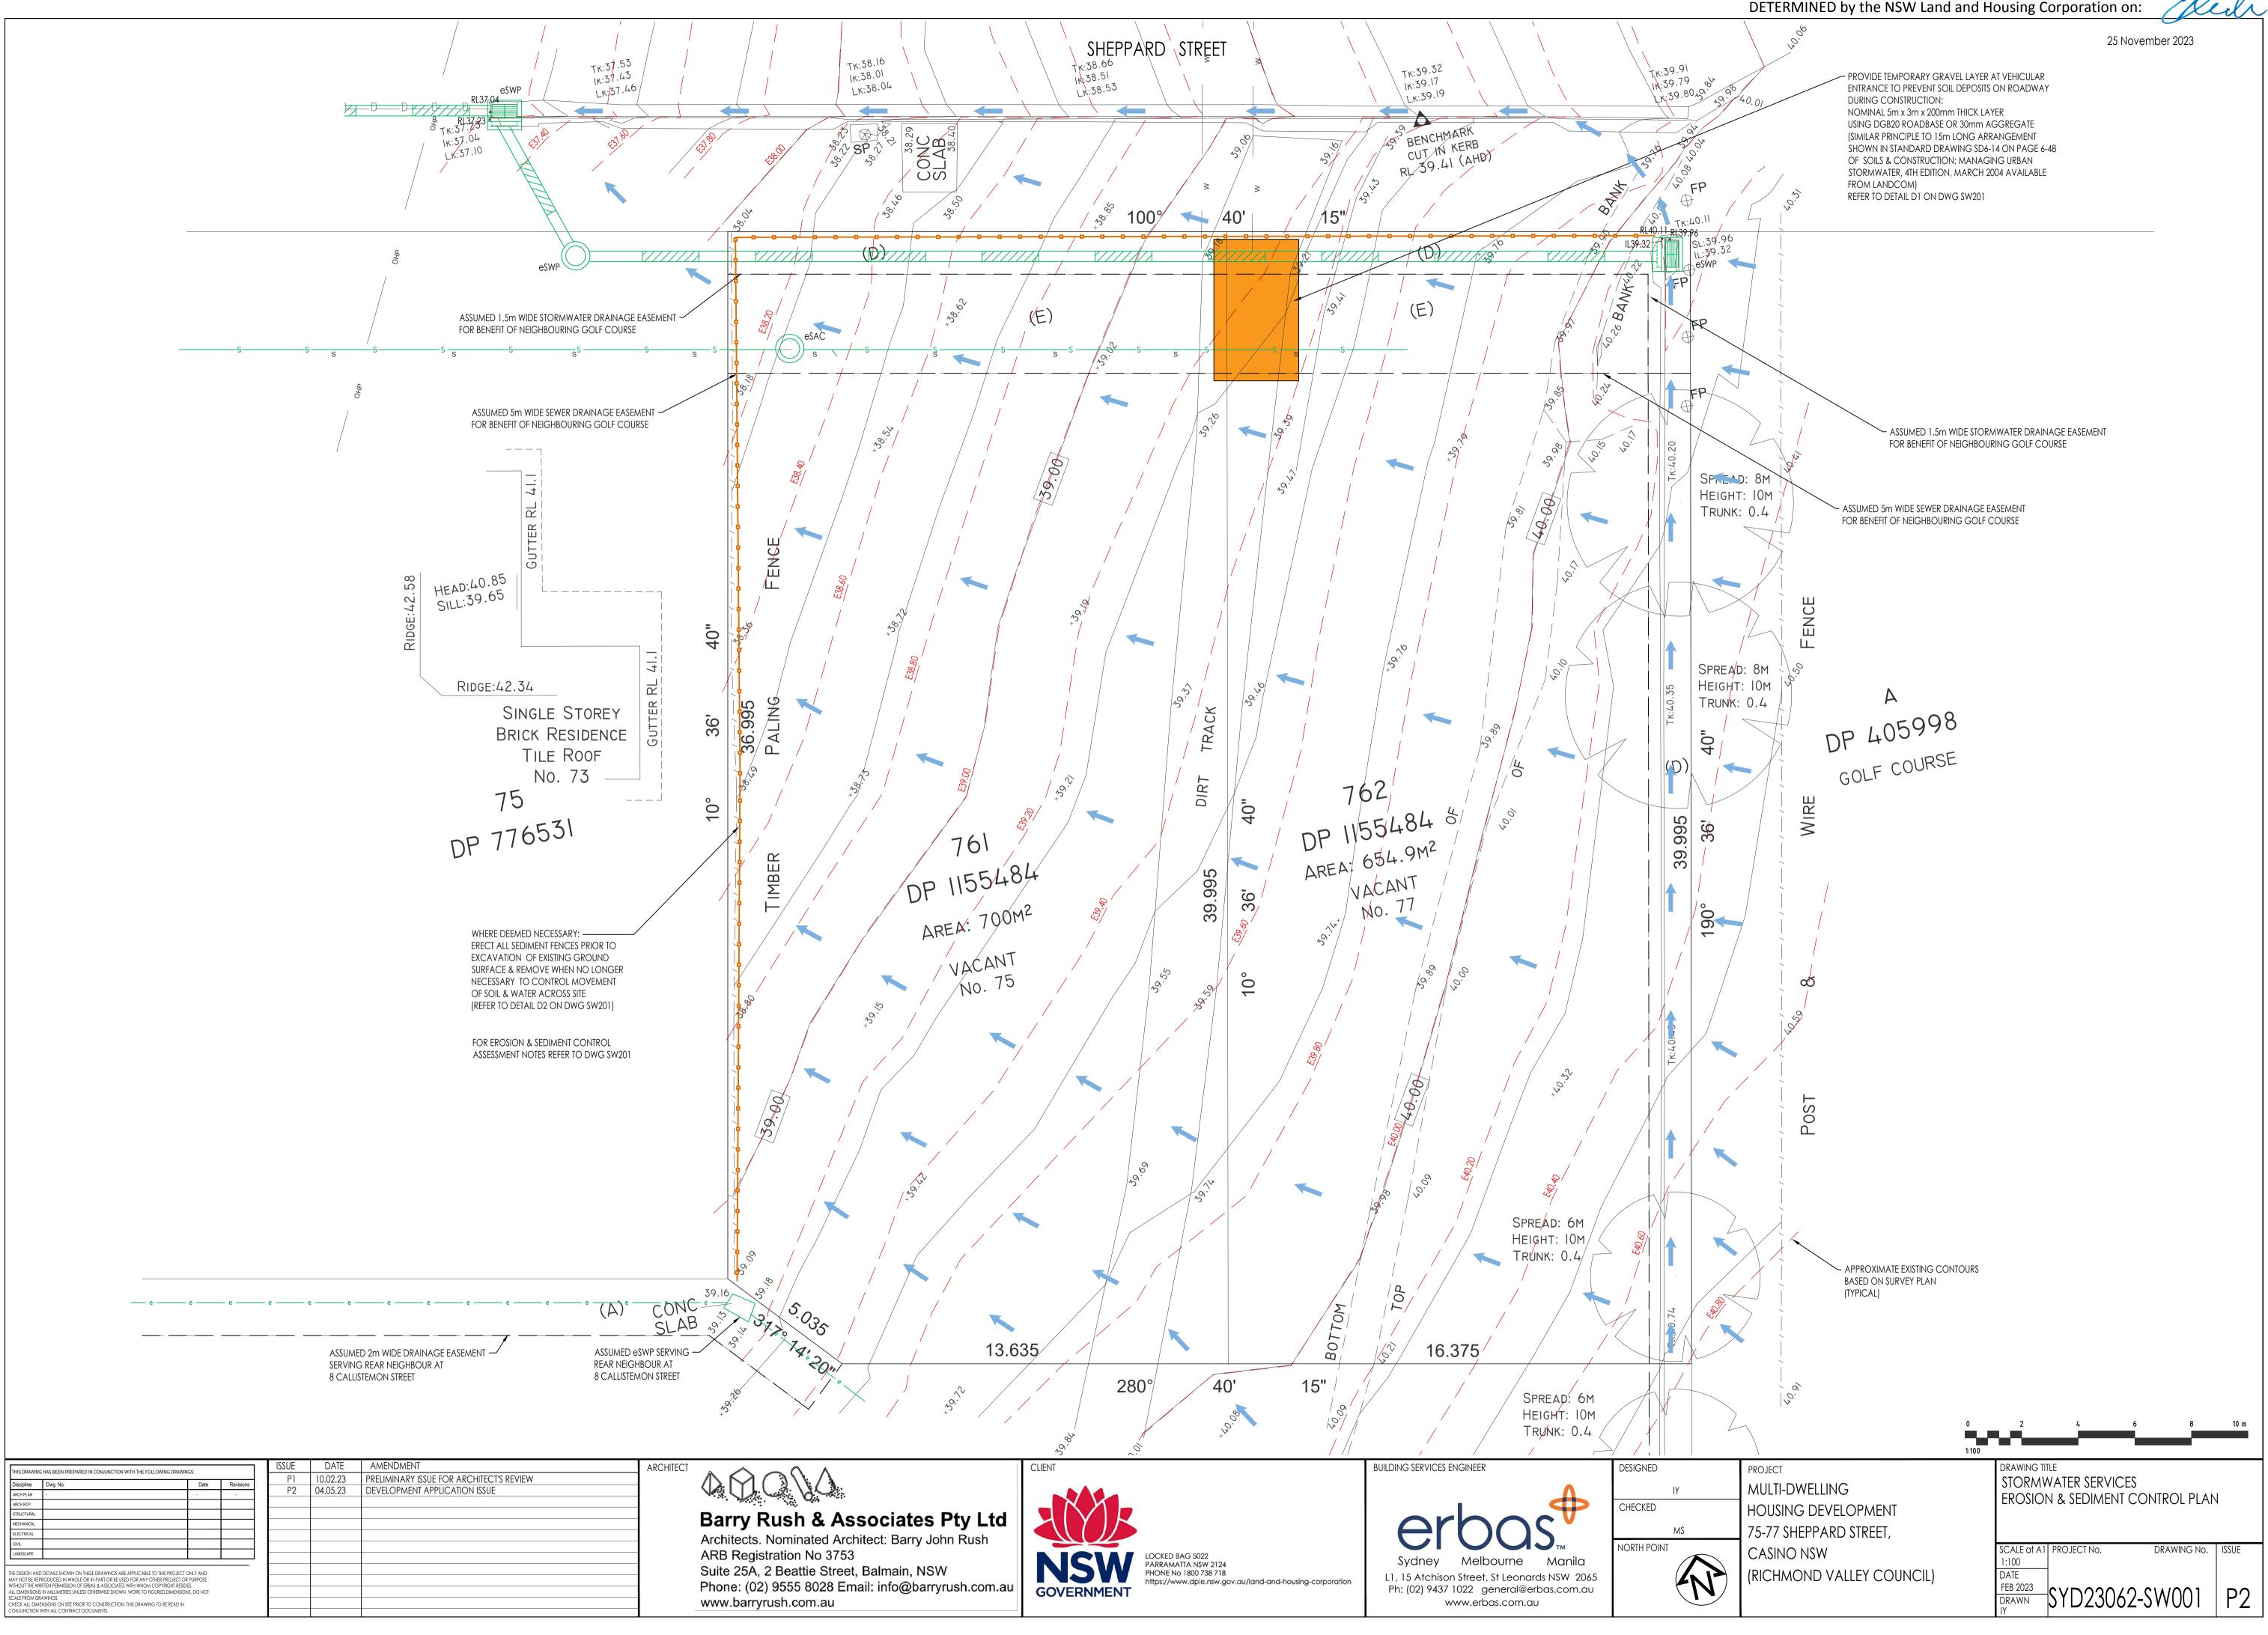

25 November 2023

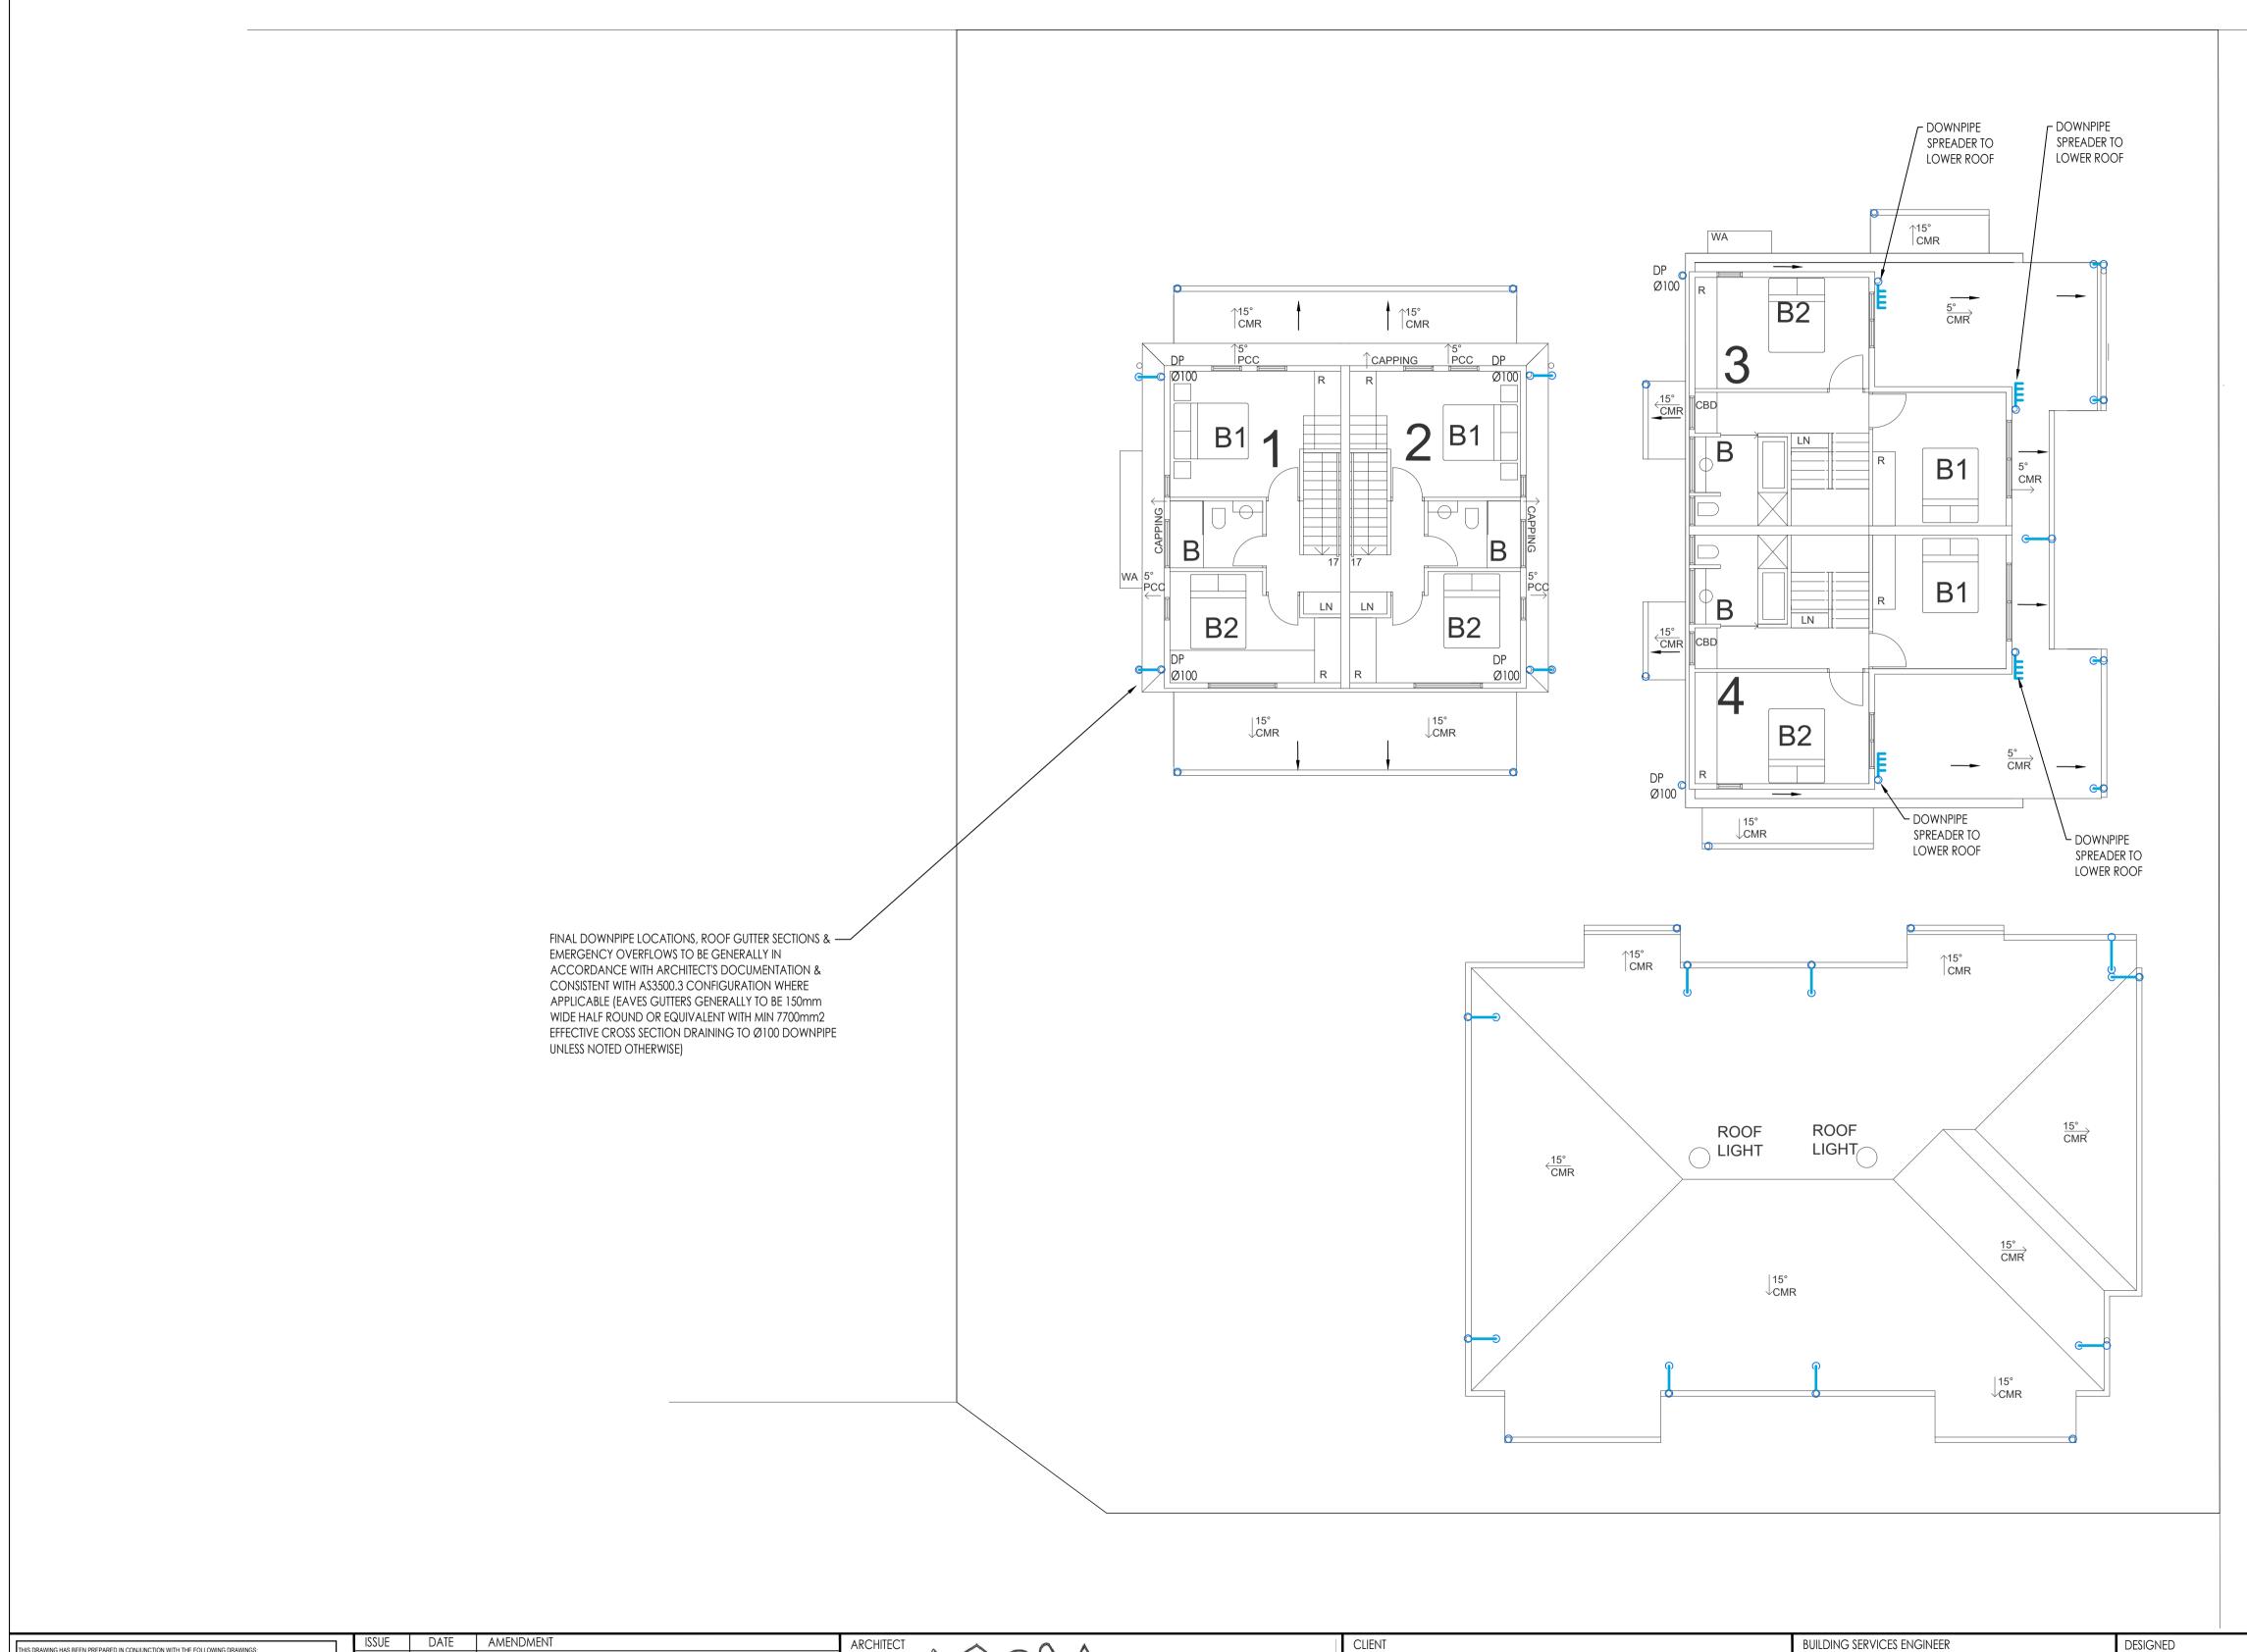

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THIS DRAWING HAS BEEN PREPARED IN CONJUNCTION WITH THE FOLLOWING DRAWINGS: P1 10.02.23 PRELIMINARY ISSUE FOR ARCHITECT'S REVIEW
P2 04.05.23 DEVELOPMENT APPLICATION ISSUE THE DESIGN AND DETAILS SHOWN ON THESE DRAWINGS ARE APPLICABLE TO THIS PROJECT ONLY AND MAY NOT BE REPRODUCED IN WHOLE OR IN PART OR BE USED FOR ANY OTHER PROJECT OR PURPOSE WITHOUT THE WRITTEN PERMISSION OF ERBAS & ASSOCIATES WITH WHOM COPYRIGHT RESIDES.
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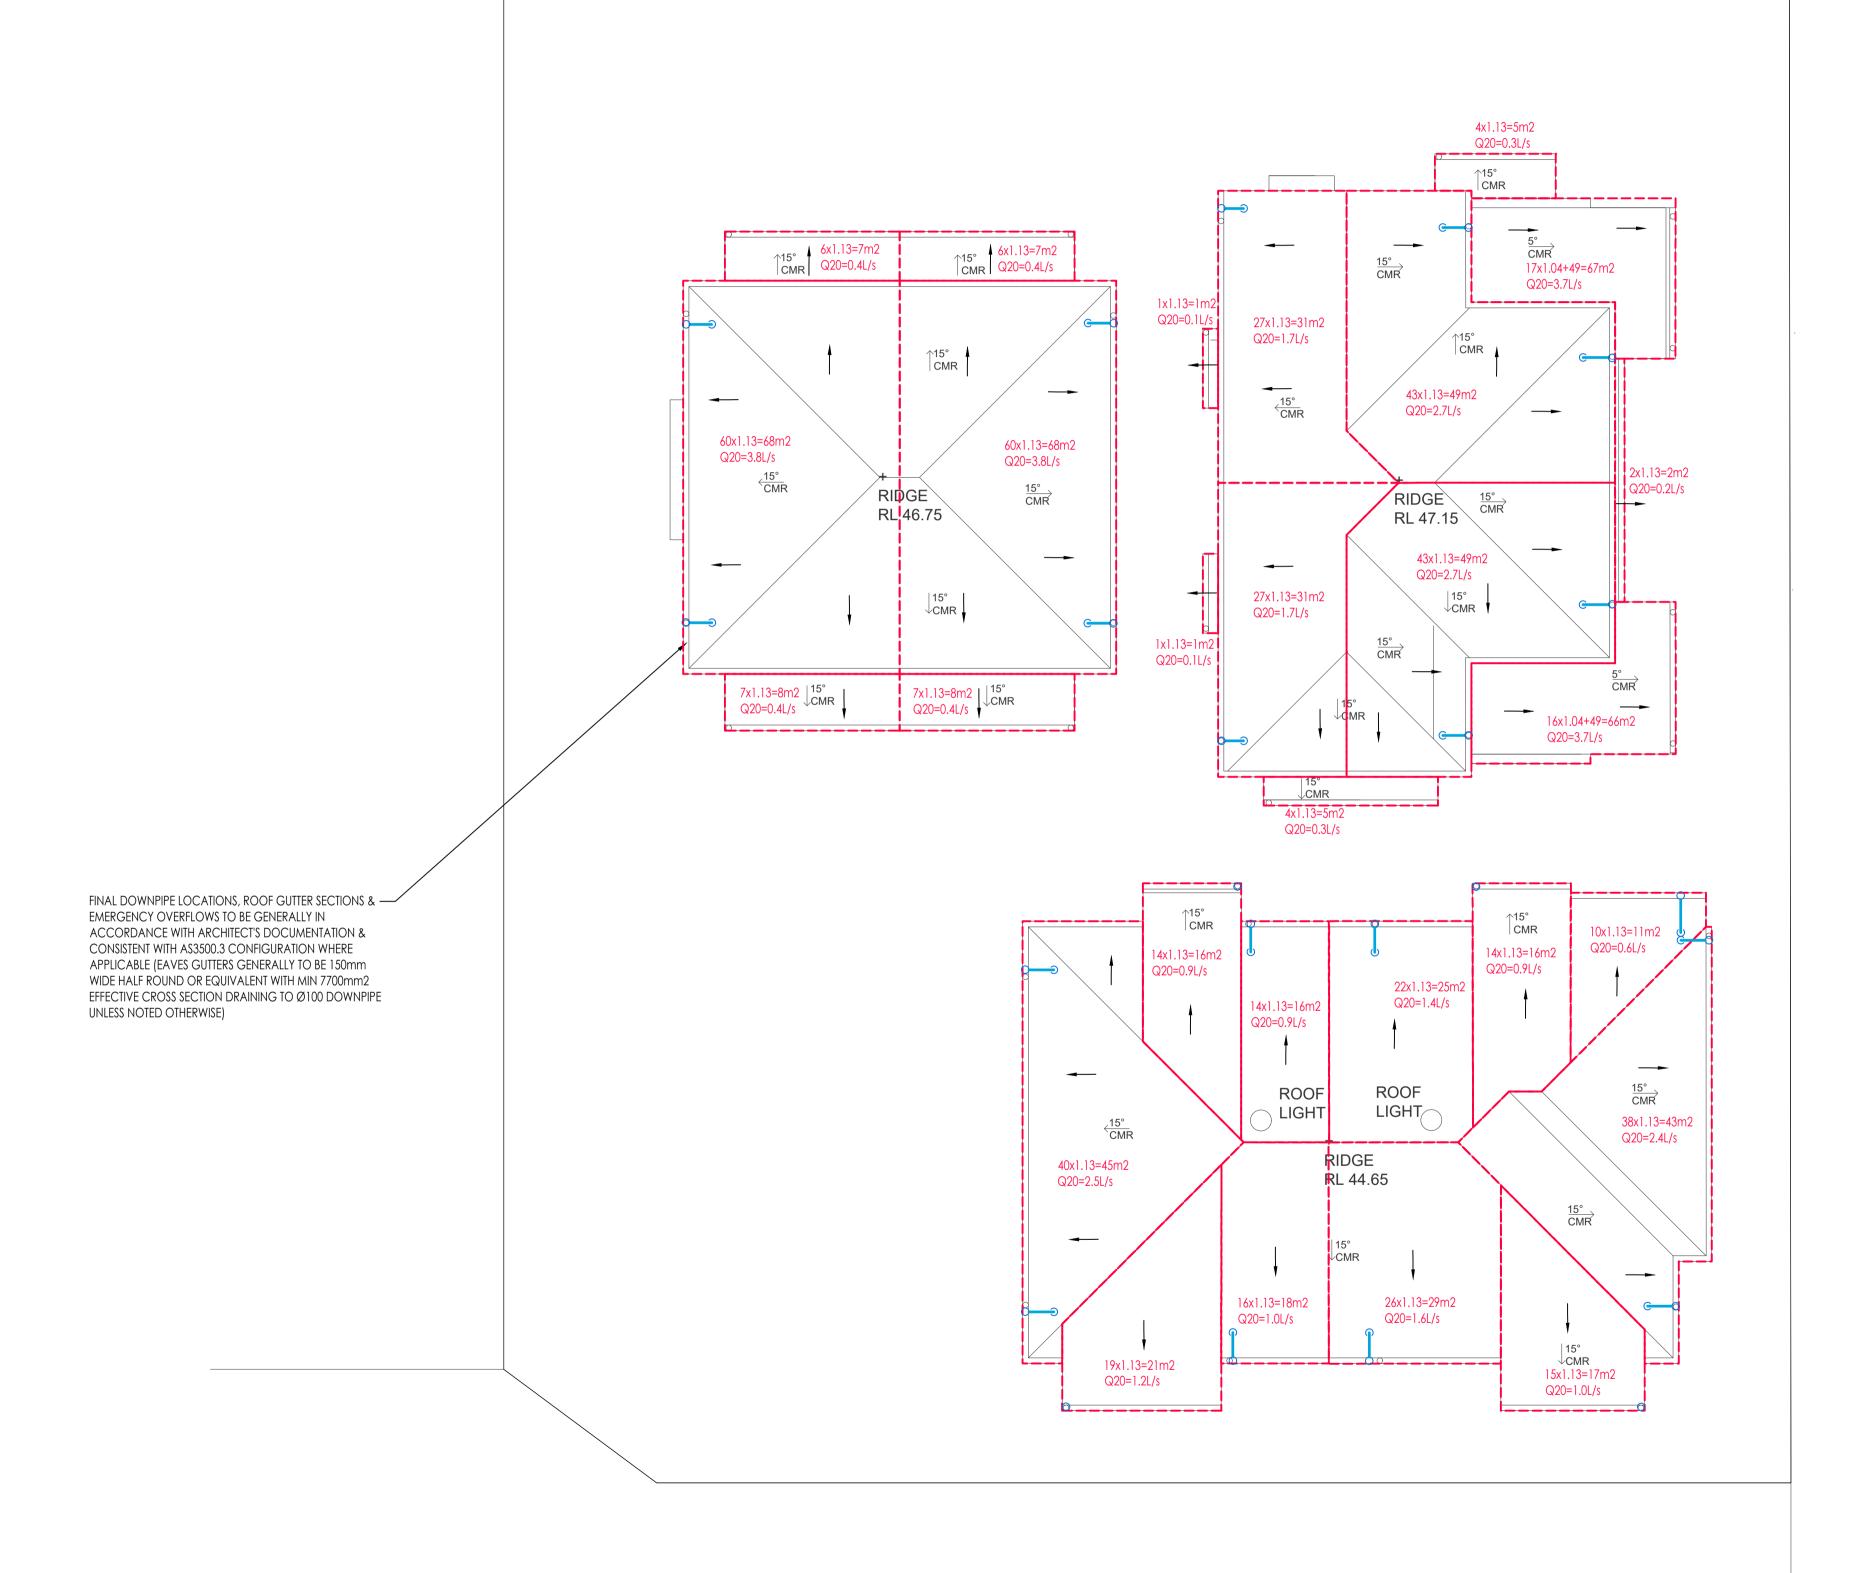
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PROJECT
MULTI-DWELLING
HOUSING DEVELOPMENT
75-77 SHEPPARD STREET,
CASINO NSW
(RICHMOND VALLEY COUNCIL)

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		vater services Dor Plan		
	1:100 DATE	PROJECT No.	DRAWING No.	ISSUE
	DRAWN	SYD23062-	-SW102	P2

25 November 2023





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Discipline	Dwg. No.	Date	Revisions	⊢	P2		
ARCH PLAN	DA01 - 09 Sheppard St Casino for CONSULTANTS 030523 (CAD FILE)	03.05.23	-	⊢	ΓZ	04.05.23	DEVELOPMENT APPLICATION ISSUE
ARCH RCP							
STRUCTURAL							
MECHANICAL							
ELECTRICAL							
CIVIL				⊢			
LANDSCAPE				H			
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AY NOT BE REP ITHOUT THE WR LL DIMENSIONS CALE FROM DR HECK ALL DIME	DETAILS SHOWN ON THESE DRAWINGS ARE APPLICABLE TO THIS PROJECT OF RODUCED IN WHOLE OR IN PART OR BE USED FOR ANY OTHER PROJECT OF STITEN PERMISSION OF ERBAS & ASSOCIATES WITH WHOM COPYRIGHT RESID IN MILLIMETIES UNLESS OTHERWISE SHOWN, WORK TO FIGURED DIMENSION AWINGS. **SHONS ON SITE PRIOR TO CONSTRUCTION. THIS DRAWING TO BE READ IN WITH ALL CONTRACT DOCUMENTS.	R PURPOSE ES.		-			

ISSUE DATE AMENDMENT

Parry Puch 8 A

Barry Rush & Associates Pty Ltd Architects. Nominated Architect: Barry John Rush

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PROJECT

MULTI-DWELLING

HOUSING DEVELOPMENT

75-77 SHEPPARD STREET,

CASINO NSW

(RICHMOND VALLEY COUNCIL)

1:100				
	DRAWING TI STORMV ROOF P	VATER SERVIC	ES	
	SCALE at A1 1:100 DATE	PROJECT No.	DRAWING No.	ISSUE
	FEB 2023 DRAWN IY	SYD2306	52-SW103	P2

- Survey plan prepared by RPS Australia East Pty Ltd - Drawing Reference 151687 [Rev 1] - dated 24/05/2022 indicates Australian Height Datum (AHD) site surface contours ranging from a localised high point of about RL40.74 near the southeast corner of the site down to about RL38.04 at the northwest corner of the site. The

Based on site survey of the existing property undertaken on 1 May 2022, it was observed that existing underground street drainage includes a kerb inlet pit near the

Based on Richmond Valley Council - Development Control Plan 2021 - Part A-1 Dwelling Houses in the R1 General Residential Zone, Table A1.13 requires each dwelling to be provided with a minimum 5000L rainwater storage tank. Rainwater storage requirements for new residential dwellings are also typically provided to satisfy State Environmental Policy Building Sustainability Index (BASIX) assessment requirements. It is proposed that an equivalent 5000L rainwater storage will be provided

Based on Richmond Valley Council - Development Control Plan 2021 - Part A-1 Dwelling Houses in the R1 General Residential Zone, Table A1.13 requires at least 80%

It is proposed that an equivalent 5000L rainwater storage will be provided for each of 6 dwellings (total 30m3) AND at least 80% of impervious ground surfaces will be

It is proposed that an equivalent 5000L rainwater storage will be provided for each of 6 dwellings (total 30m3) AND at least 80% of impervious ground surfaces will be

Based on Richmond Valley Council - Development Control Plan 2021 - Part A-1 Dwelling Houses in the R1 General Residential Zone, Table A1.13 requires erosion and sediment control measures to be implemented. During construction works the management of soil and water movement requiring erosion and sediment control is to be undertaken in accordance with the Landcom publication Soils and Construction: Managing Urban Stormwater 4th Edition, March 2004 (also known as "the Blue Book").

Based on Richmond Valley Council - Development Control Plan 2021 - Part I-9 Water Sensitive Design, Table I-9.2 for residential lots requires either

Based on Richmond Valley Council - Development Control Plan 2021 - Part I-9 Water Sensitive Design, Table I-9.4 for residential lots requires either

STORMWATER MANAGEMENT PLAN INFORMATION

- Richmond Valley Council - Development Control Plan 2021 - Part I-9 Water Sensitive Design

- Located approximately 100m west of Links Avenue, on south side of Sheppard Street.

75-77 Sheppard Street, Casino NSW

- Richmond Valley Council - Development Control Plan 2021 - Part A-1 Dwelling Houses in the R1 General Residential Zone

Based on the Casino Floodplain Hazard Categories map the subject property at is NOT considered to be affected by flooding.

It is proposed that site drainage from the new development will be directed to the existing street pit in Sheppard Street.

of proposed impermeable ground surface to be directed towards lawn or garden areas, to promote natural infiltration.

- a minimum 5000L rainwater tank for each dwelling to capture at least 50% of the associated roof area OR

- a minimum 5000L rainwater tank for each dwelling to capture at least 50% of the associated roof area OR

- an infiltration/absorption system to capture at least 80% of total roof area OR

- an infiltration/absorption system to capture at least 80% of total roof area OR

graded to direct runoff towards lawn or garden areas on the western side of the site.

graded to direct runoff towards lawn or garden areas on the western side of the site.

- a bioretention system to capture at least 80% of total roof area

- a bioretention system to capture at least 80% of total roof area

TEMPORARY EROSION & SEDIMENT CONTROL MEASURES

Temporary construction measures to be undertaken include:

DEVELOPMENT AUTHORITY: Richmond Valley Council

SITE ADDRESS:

- Site area = 1355m2

DEVELOPMENT GUIDELINES

EXISTING SITE CHARACTERISTICS

- Two existing vacant residential lots

LOCAL FLOODING EFFECTS

EXISTING STREET DRAINAGE

PROPOSED CONNECTION

for each of 6 dwellings (total 30m3).

STORMWATER QUALITY

STORMWATER GENERATION


RAINWATER STORAGE


average site slope is observed to be about 5%.

northwest corner of the site, on the south side of Sheppard Street.


25 November 2023


Based on Soils and Construction: Managing Urb	an Stormwater -	4th Edition - March	2004	
Assumed area of Soil Disturbance	=	1355 m2 =	0.1355 ha	
Rainfall Erosivity Factor R	=	3400 for	CASINO from APPENDIX B: MAP 2 ON PAGE B-4	
Take Site Slope	=	5 %		
•	rosion Hazard is	LOW	based on Section 4.4.1 Figure 4.6 on page 4-10	
Use Revised Universal Soil Loss Equation (RUSL	E) to check:			
Soil Erodibility Factor K	=	0.060 for	CASINO from www.environment.nsw.gov.au/espade2webapp	
Slope Length/Gradient Factor Ls	=	1.19 from APF	PENDIX A: USING 80m LENGTH IN TABLE A1 ON PAGE A-9	
Erosion Control Practice Factor P	=	1.3 from APF	PENDIX A: TABLE A2 ON PAGE A-11	
Ground Cover & Management Factor C	=	1.0 from APF	PENDIX A: FIGURE A5 ON PAGE A-12	
Soil Loss	=	316 t/ha/yr		
Soil Loss Class	=	3 for	SOIL LOSS BETWEEN 226 & 350t/ha/yr based on SECTION 4.4.2 TABLE 4.2 ON PAGE 4-13	
Erosion Haz	ard is therefore	LOW-MODERATE	AND THERE ARE NO SEASONAL RESTRICTIONS ON SITE ACTIVITY	
For 1.0 t/m3 density, Average Annual Soil Loss	=	316 m3/yr	SINCE THIS IS GREATER THAN THAN 150m3/yr, A SEDIMENT BASIN WOULD BE CONSIDERED NECESSARY	based on SECTION 6.3.2(d) ON PAGE 6-8
			UNLESS INDIVIDUAL SOIL DISTURBANCE AREAS CAN BE LIMITED TO 2500m2 OR LESS	
			FOR THE AREA TO BE DISTURBED ON THIS SITE, SEDIMENT FENCES ARE CONSIDERED SATISFACTORY	
10yr 5min RAINFALL INTENSITY	=	185 mm/h	Refer to SECTION 2.1 ON PAGE 2-1, SECTION 4.4.1(a) ON PAGE 4-9 & SECTION 4.3.2(h)(iv) ON PAGE 4-4	
10yr 1hr RAINFALL INTENSITY	=	55.7 mm/h	LENGTHS OF SEDIMENT FENCING SHOULD BE ARRANGED TO LIMIT SUBCATCHMENT FLOWS TO 50L/s	

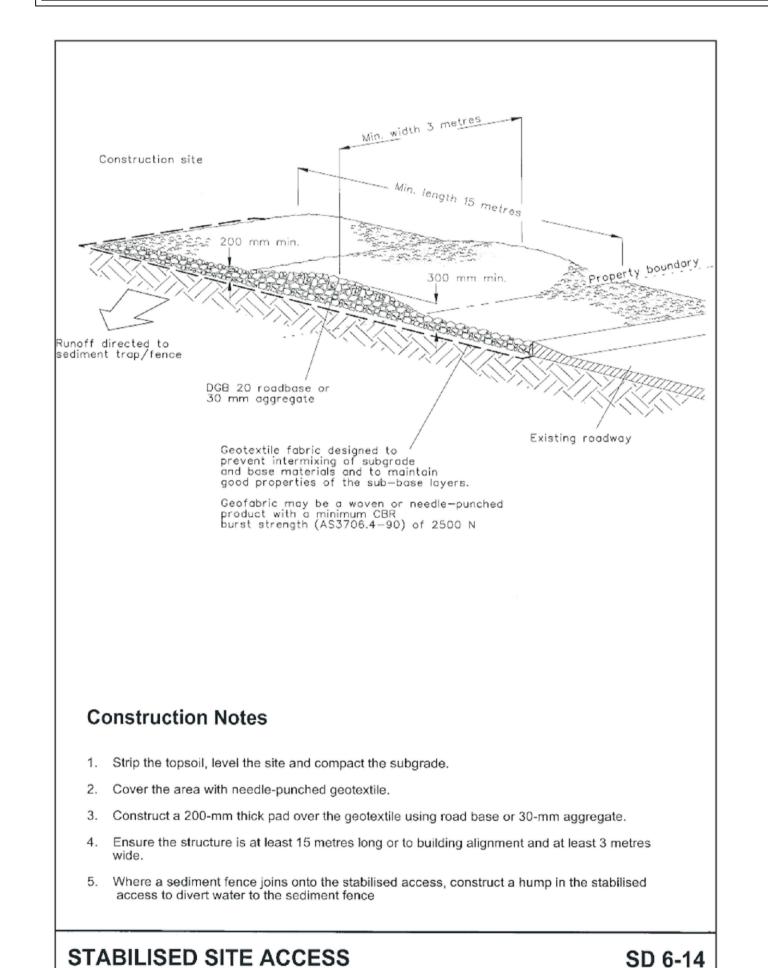

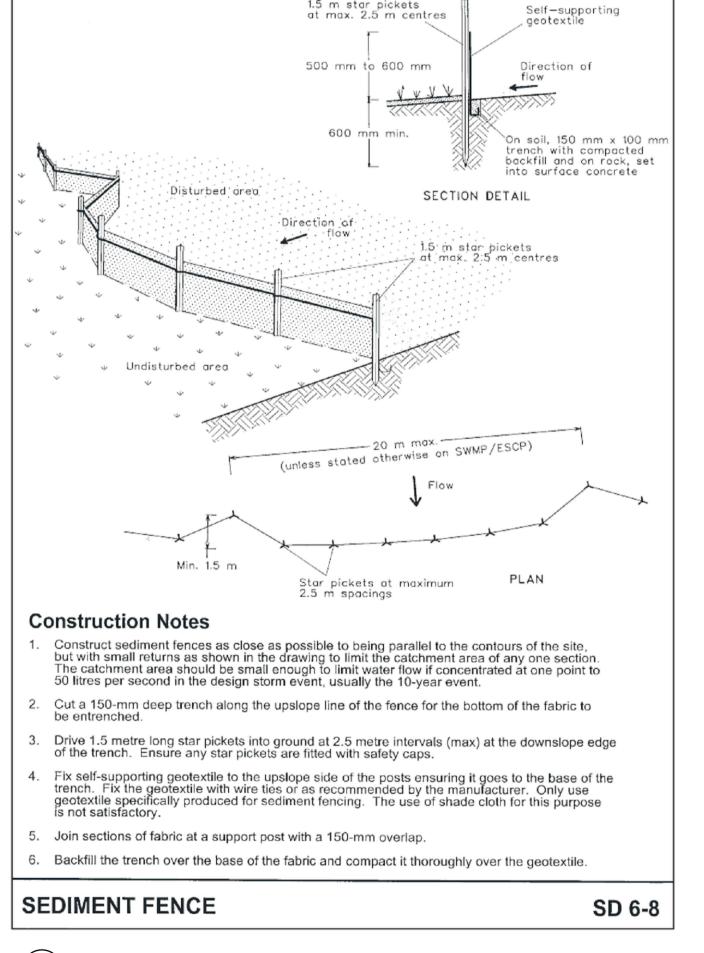

1.5 m star pickets

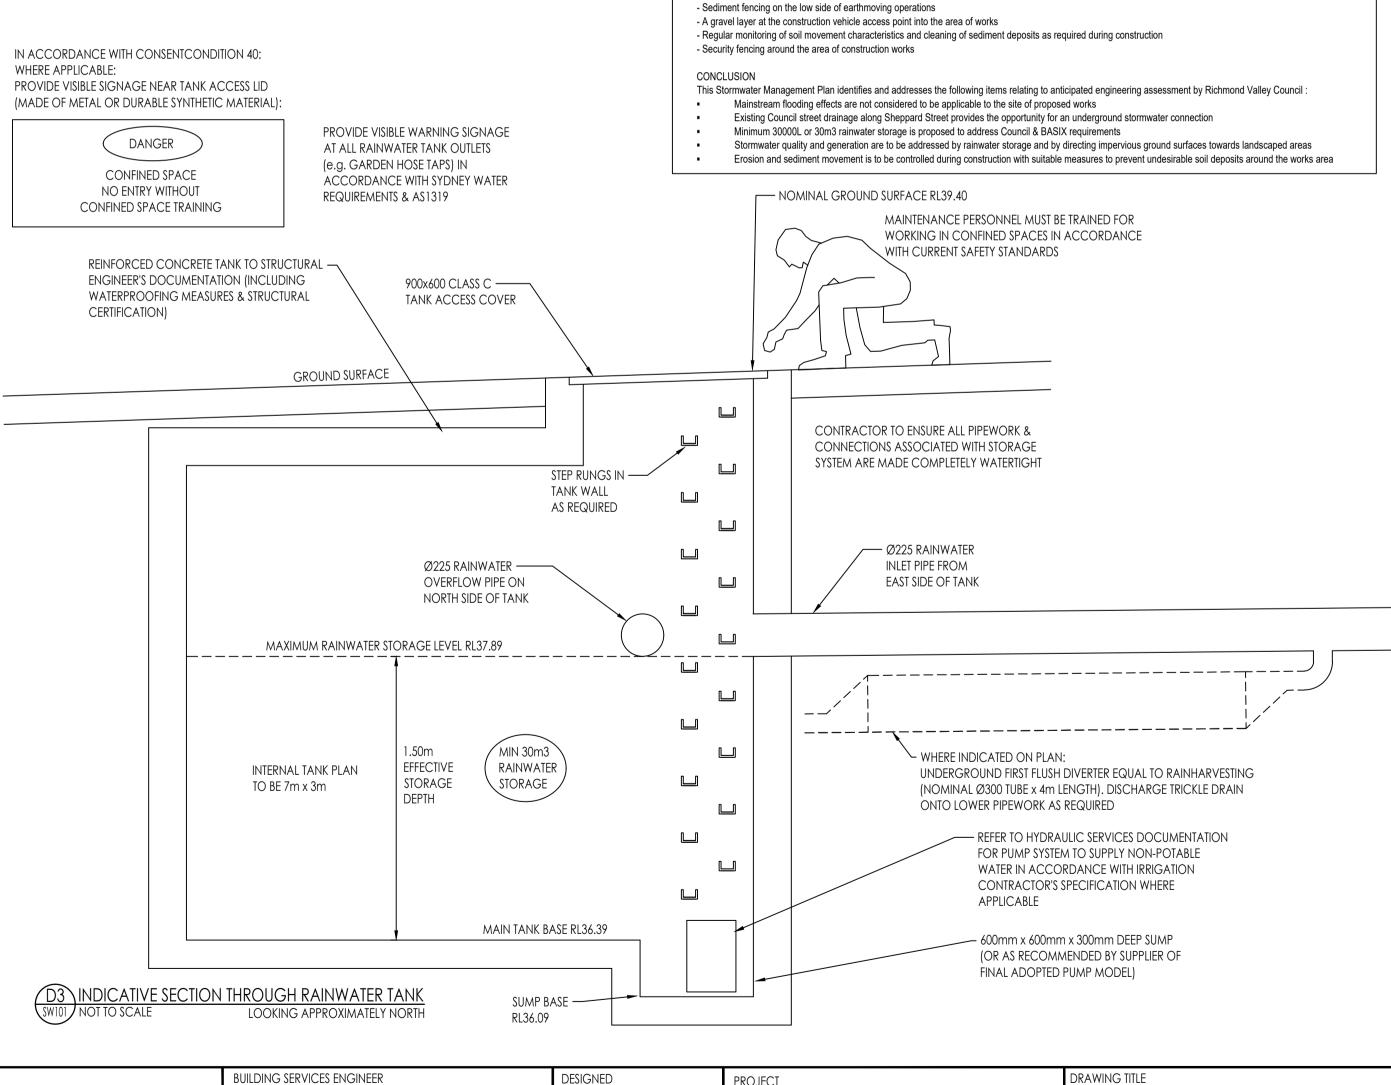

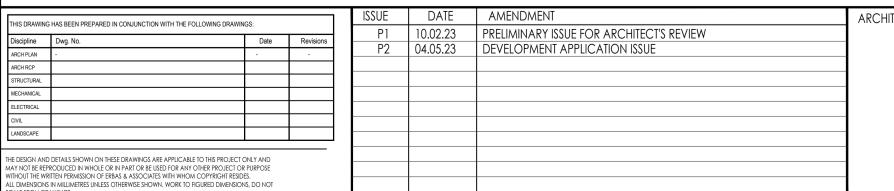

D1 STABILISED SITE ACCESS

HECK ALL DIMENSIONS ON SITE PRIOR TO CONSTRUCTION. THIS DRAWING TO BE READ IN

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Barry Rush & Associates Pty Ltd

Architects. Nominated Architect: Barry John Rush ARB Registration No 3753 Suite 25A, 2 Beattie Street, Balmain, NSW

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DESIGNED PROJECT MULTI-DWELLING CHECKED HOUSING DEVELOPMENT 75-77 SHEPPARD STREET NORTH POINT CASINO NSW (RICHMOND VALLEY COUNCIL)

DRAWING TITLE STORMWATER SERVICES DETAIL SHEET SCALE at A1 PROJECT No. DRAWING No. | ISSUE

STORMWATER PIPE SCHEDULE

STORMWATER PIPE SIZING BY RATIONAL FORMULA & COLEBROOK-WHITE EQUATION Coefficient of runoff determined in accordance with Ch. 14 of AR & R (1987)

PROJECT: 75-77 SHEPPARD ST CASINO

Design rainfall intensity = 213.00 mm/h Pipe roughness k = 0.015 mm ARI = 20 years Fy = 1.05 10 year 1 hour intensity = 55.70 mm/h

ARI = 20 year	s Fy =	1.05	10 yea	ar 1 hour	intensi	ty = 55.7	0 mm/h	
U/S NODE D/S	NODE AREA m2	IMPERV %	COEF	SLOPE %	INFLOW L/s	PIPEFLOW L/s	CAP L/s	SIZE mm
5 6 7 8 9 10 11 12 13 14 15 16 7 18 19 20 1 22 22 23 24 22 25 27 28 29 30 31 32 33 33 33 33 33 33 33 33 33 33 33 33	2 6 3 30 4 30 22 7 6 9 30 8 4 9 27 10 0 11 1 14 1 13 30 14 7 21 0 16 30 17 30 18 2 19 30 51 20 28 0 24 29 25 14 26 22 27 14 28 14 36 0 30 19 31 15 32 26 33 16 34 19 35 20 36 30 37 0 39 31 35 20 36 30 37 0 39 31 35 20 36 37 0 39 31 35 20 36 37 0 39 31 35 20 36 37 0 39 31 35 20 36 37 0 39 31 35 20 36 37 0 39 31 35 20 36 37 0 39 31 35 20 36 37 0 39 31 35 20 36 37 0 37 0 39 31 15 32 26 33 16 34 19 35 20 36 20 37 0 39 31 35 20 36 37 0 39 31 35 32 26 37 30 39 31 35 32 26 37 30 39 31 35 32 26 37 30 39 31 35 32 26 37 30 39 31 35 32 26 37 30 39 31 35 32 26 37 30 39 31 35 32 26 37 30 39 31 35 32 26 37 30 39 31 35 32 26 37 30 39 31 35 32 26 37 30 39 31 35 32 26 37 30 39 31 35 32 26 37 30 30 31 31 35 32 36 37 30 30 31 31 35 32 36 37 30 30 31 31 35 32 36 37 30 30 31 31 35 32 36 37 30 30 31 31 35 32 36 37 30 30 31 31 35 32 36 37 30 30 31 31 35 32 36 37 30 30 31 31 35 32 36 37 30 30 31 31 35 32 36 37 30 30 31 31 31 35 32 36 37 30 30 31 31 31 35 32 36 37 30 30 31 31 31 35 32 36 37 30 30 31 31 31 31 31 31 31 31 31 31 31 31 31	100 100 100 100 100 100 100 100 100 100		1.00 1.00	0.3 1.7 0.4 0.3 1.7 0.4 0.3 1.7 0.1 0.1 0.1 0.1 0.1 1.7 0.0 0.1 1.7 1.7 0.0 0.1 0.1 0.1 0.1 0.1 0.1 0.1 0.1 0.1	4.1 0.3 2.0 0.2 1.7 3.8 9.7 2.1 5.7 3.5 5.1 8.6 5.1 8.6 5.1 8.6 5.1 8.6 4.4 5.2	8.000000000000000000000000000000000000	

STORMWATER PIT SCHEDULE

Label	No:	Pit Size	Surface RL	Outlet IL	Pit Depth	Lid Type	Load Class
SWP	1	900x900	38.15	37.00	1150	Cover	O
SWP	2	450x450	38.55	37.95	600	Grate	O
SWP	3	450x450	39.20	38.60	600	Grate	Α
SWP	4	450x450	39.20	38.70	500	Grate	A
SWP	5	450x450	39.70	39.20	500	Grate	A
SWP	6	450x450	39.70	39.20	500	Grate	Α
SWP	7	450x450	39.80	39.30	500	Grate	Α
SWP	8	450x450	40.20	39.60	600	Grate	Α
GTD	1	300 WIDE	38.15	VERTICAL	MIN 200	Grate	С

- 1. PITS TO BE REINFORCED CONCRETE IN ACCORDANCE WITH AS3500.3
- 2. GRATES GENERALLY TO BE HINGED GALVANISED MILD STEEL EQUAL TO BR DURHAM &
- SONS (ADOPT HEELPROOF STYLE WHERE APPLICABLE) 3. COORDINATE REBATE & CHANNEL DIMENSIONS WITH SLAB CONSTRUCTION TO SUIT TRENCH DRAIN DIMENSIONS AS NECESSARY (WITH STRUCTURAL ENGINEER'S APPROVAL/SUPERVISION)
- 4. FALL BASE OF TRENCH DRAINS TO OUTLET AT MIN 1%.
- 5. LIAISE WITH BUILDER TO ENSURE CONCRETE WORKS ASSOCIATED WITH PIT/TRENCH
- LOCATIONS ARE ACCURATELY COORDINATED AS REQUIRED.
- 6. GENERALLY GRADE SURROUNDING SURFACES TO DIRECT STORMWATER INTO GRATES. 7. MINIMUM LOAD CLASS RATINGS ARE PROVIDED. IF A SPECIFIC LOAD CLASS IS NOT
- COMMERCIALLY AVAILABLE, ADOPT THE NEXT HIGHER LOAD CLASS.
- 8. PROVIDE STEP RUNGS WHERE PIT DEPTH EXCEEDS 1.2m.

				ISSUE	DATE	AMENDMENT	
THIS DRAWIN	G HAS BEEN PREPARED IN CONJUNCTION WITH THE FOLL	DWING DRAWINGS:		P2	04.05.23	DEVELOPMENT APPLICATION ISSUE	
Discipline	Dwg. No.	Date	Revisions	12	04.00.20	DEVELOT MENT AT LICATION 1330E	
ARCH PLAN	-	-	-				
ARCH RCP							
STRUCTURAL							
MECHANICAL							
ELECTRICAL							
CIVIL							
LANDSCAPE				-		+	
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1. COLEBROOK-WHITE ROUGHNESS k = 0.015mm FOR POLYVINYL CHLORIDE PIPE (PVC). A MINIMUM PIPE SLOPE OF 1.00% IS ASSUMED FOR CALCULATION PURPOSES.

CONFIRM PRACTICALITY OF PIPE INSTALLATION & ADVISE OF ANY DISCREPANCY PRIOR TO CONSTRUCTION.

10. THE ENTIRE DRAINAGE INSTALLATION SHALL COMPLY WITH THE RELEVANT PROVISIONS OF AS3500.3.

TO BE MARKED WITH RED INK TO INDICATE CHANGES TO THE ORIGINAL DESIGN LAYOUT.

CONFIRMATION FROM THE RELEVANT PARTY THAT THE CURRENT HOURLY RATE FEE WILL BE PAID.

SUSPENDED STORMWATER DRAINAGE TO BE SEWER GRADE UPVC WITH SOLVENT WELDED JOINTS SUPPORTED AS PER AS3500.3 CLAUSE 4.9.6.2. STORMWATER DRAINAGE TO BE SEWER GRADE UPVC WITH SOLVENT WELDED JOINTS LAID ON GRANULAR BEDDING TO AS3500.3 CLAUSE 6.3.1.2.

CONFIRM ALL SUBSOIL DRAINAGE REQUIREMENTS PRIOR TO CONSTRUCTION & COORDINATE WITH FOOTING LEVELS WHERE APPLICABLE.

17. AS-BUILT DRAWING/SURVEY OF COMPLETED WORKS SHOULD BE MADE AVAILABLE TO VIEW PRIOR TO ARRANGING FOR FINAL SITE INSPECTION.

9. ALL DRAINAGE TO BE MIN Ø100 UNLESS NOTED OTHERWISE. ENSURE PIPE BENDS GENERALLY DO NOT EXCEED 45 DEGREES IN PLAN.

14. FINAL DRAINAGE LAYOUT SHALL BE MARKED ON AS-BUILT DRAWINGS AS REQUIRED FOR CERTIFICATION & REFERENCE PURPOSES. 15. WHERE APPLICABLE, BUILDER TO PAY ALL ROAD OPENING & COUNCIL FEES ASSOCIATED WITH REQUIRED CONSTRUCTION.

18. ALL DOWNPIPES DRAINING TO THE STORAGE SYSTEM SHALL BE MADE WATERTIGHT BELOW THE MAXIMUM WATER STORAGE LEVEL.

SUBSOIL DRAINAGE (WHERE REQUIRED) TO BE SLOTTED UPVC WITH FILTER SOCK LAID IN FREE-DRAINING GRANULAR MATERIAL TO AS3500 CLAUSE 6.3.1.2.

12. ALL STORMWATER OUTLETS TO BE Ø100 FLAT GRATE EQUAL TO SPECIALITY PLUMBING SUPPLIES TRUFLO SERIES (TEL 02 9417 1900) UNLESS NOTED OTHERWISE.

19. ALL REQUIRED EASEMENTS, POSITIVE COVENANTS OR OTHER LEGAL INSTRUMENTS TO BE ARRANGED & REGISTERED BY SURVEYOR OR OTHER APPROVED AGENT.

11. WATERTIGHT INSPECTION OPENINGS OR PITS TO BE PROVIDED FOR CLEANING PURPOSES AT MAXIMUM 30m INTERVALS & IN ACCORDANCE WITH AS3500.3 CLAUSE 7.4.1.

13. BUILDER TO PROVIDE 'AS BUILT' DRAWINGS OF ALL RELEVANT DRAINAGE WORKS AS REQUIRED FOR CERTIFICATION PURPOSES. IN SOME CASES COUNCIL MAY REQUIRE APPROVED PLANS

16. SITE INSPECTIONS SHOULD BE ARRANGED IN ACCORDANCE WITH CONSENT CONDITIONS & CERTIFIER'S REQUIREMENTS, WITH REASONABLE ADVANCE NOTICE BEING GIVEN & WRITTEN

SURFACE LEVELS BASED ON ARCHITECTURAL & SURVEY DRAWINGS.

Barry Rush & Associ Architects. Nominated Architect:

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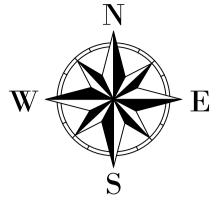
ESIGNED	PROJECT
IY	MULTI-DWELLING
HECKED	HOUSING DEVELOPMENT
MS	75-77 SHEPPARD STREET,
ORTH POINT	CASINO NSW
	(RICHMOND VALLEY COUNCIL)

DRAWING TITLE STORMWATER SERVICES DETAIL SHEET 2 DRAWING No. ISSUE SCALE at A1 PROJECT No.

	CLIENT
siatos Ptv I td	
ciates Pty Ltd Barry John Rush	
nain, NSW	LOCKED BAG 5022 PARRAMATTA NSW 2124 PHONE No 1800 738 718 https://www.dpie.nsw.gov.gu/land-and-housing-corporation







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 - C. ANY INACCURACIES OR OTHER FAULTS WITH INFORMATION OR DATA SOURCED FROM A THIRD
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- 6. SERVICES SHOWN ARE INDICATIVE ONLY. POSITIONS ARE BASED ON DIAL BEFORE YOU DIG PLANS DATED 30th AUGUST 2022, PROVIDED BY THE RELEVANT AUTHORITIES AND FROM VISIBLE SURFACE LIDS/INDICATORS. CONFIRMATION OF THE EXACT POSITION SHOULD BE MADE PRIOR TO ANY EXCAVATION WORK. OTHER SERVICES MAY EXIST WHICH ARE NOT SHOWN.
- 7. LEVELS ARE BASED ON AUSTRALIAN HEIGHT DATUM (AHD) USING PM 26577 WITH RL OF 41.048 LOCATED AT ----.
- ORIGIN OF CO-ORDINATES PM 26577 WITH MGA (GDA2020) CO-ORDINATE VALUES OF E504454.143, N6809544.322
- CONTOUR INTERVAL 0.25m. CONTOURS ARE AN INDICATION OF LANDFORM AND SHOULD NOT BE TAKEN IN PREFERENCE TO SPOT LEVELS SHOWN.

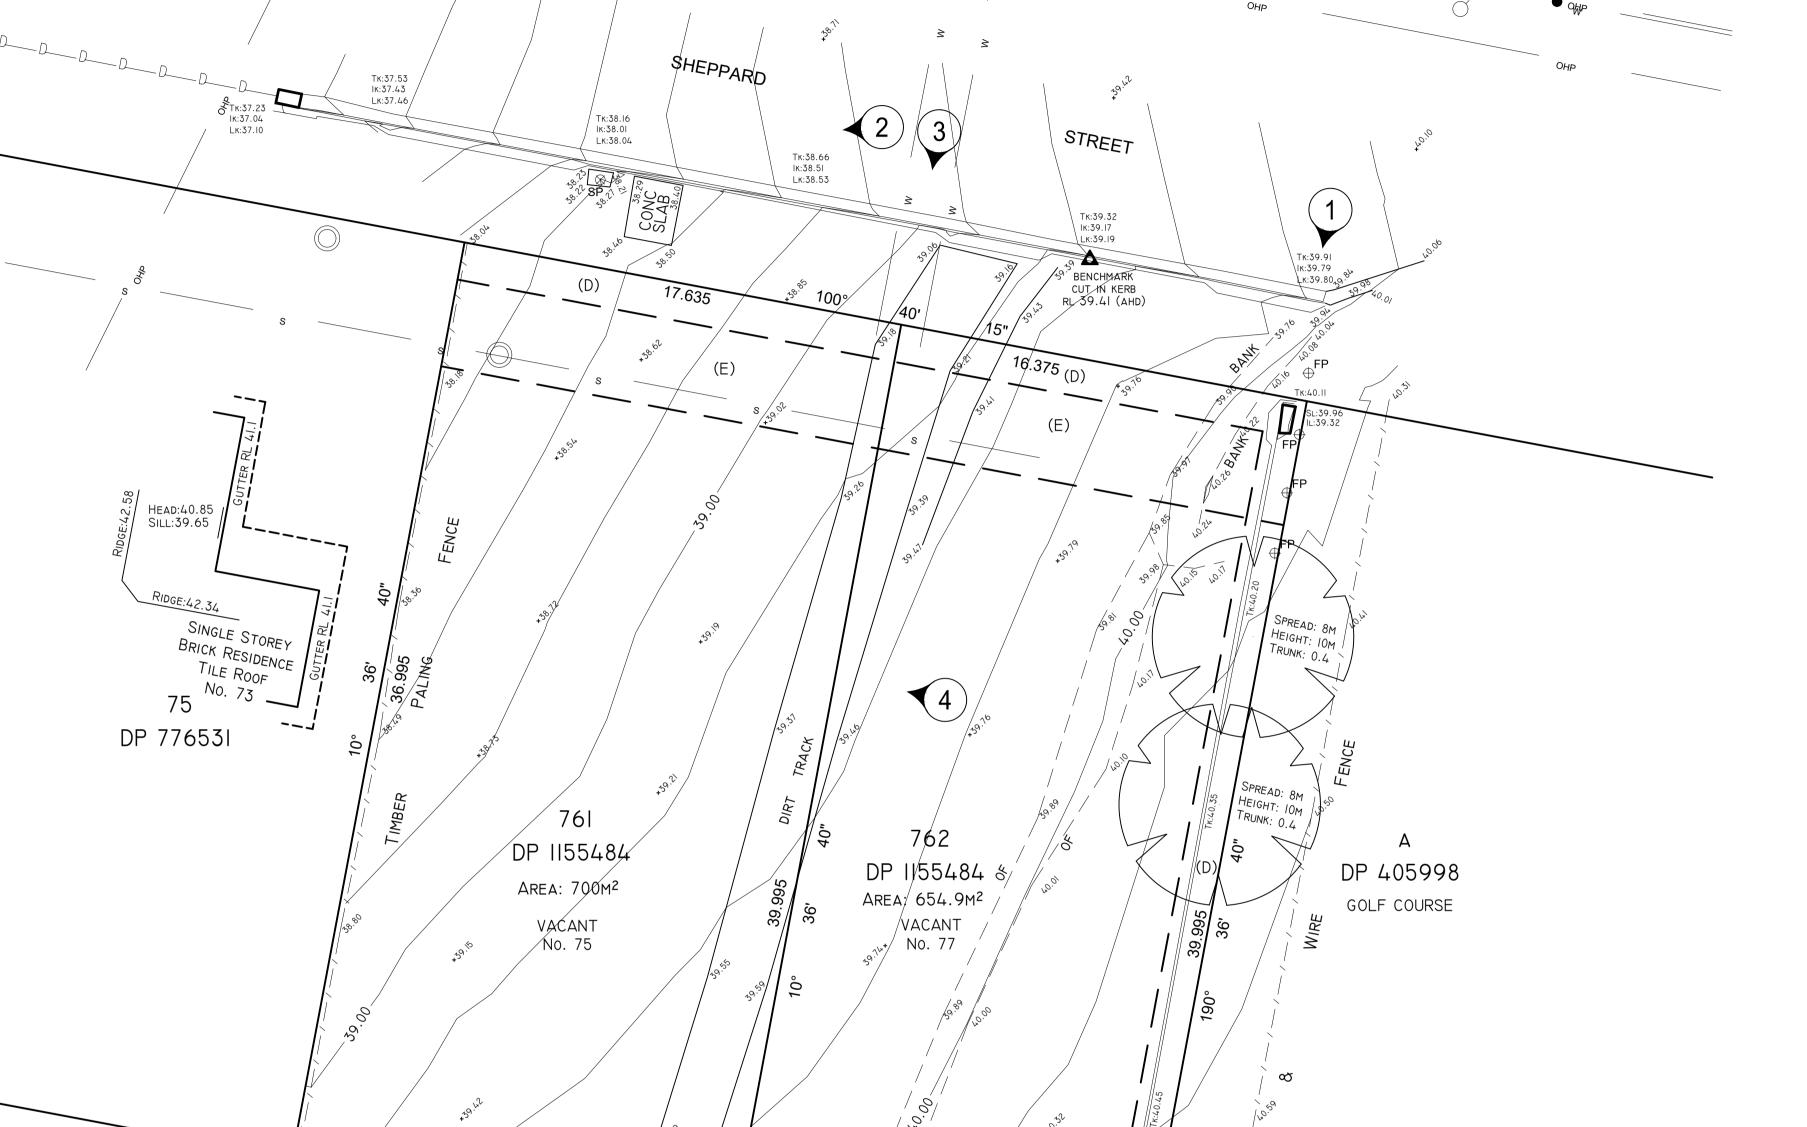




Photo 1




Photo 2



Photo 3



Photo 4

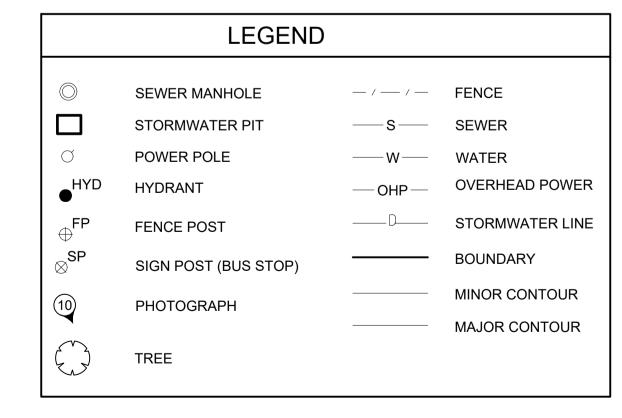

EASEMENT NOTES

- (A) EASEMENT TO DRAIN WATER 2 WIDE VIDE DP776531
- (D) EASEMENT TO DRAIN WATER 1.5 WIDE VIDE DP776531
- (E) EASEMENT FOR SEWER 5 WIDE

DATE	NOTATION/AMENDMENT	No. DATE	NOTATION/AN	MENDMENT	CONTOUR INTERVAL: 0.25m	LEGEND OF COMMONLY USED SYMBOLS	REDU	JCTION RATIO 1 : ¹⁵⁰	DATE OF SURVEY: 01 / 05 /20 22		LOCATION	
					DATUM: AHD		0		SURVEY CONSULTANT:	Land & Housing	CASINO	
13-02-2023	Easement Note Updated				ORIGIN OF DATUM: PM ****			LAND TITLE INFORMATION	PDS Australia Fast	Corporation	STREET ADDRESS	TYPE
					100 YEAR FLOOD RL:		LOTS:	LOTS 761 AND 762		DIVISION OF THE DEPARTMENT OF FAMILY & COMMUNITY SERVICES DRAWING TITLE	75-77 Sheppard Street, Casino	S
		FILE	FILE SIZE (MB)	CHECKED BY	RECOMMENDED MINIMUM FLOOR RL:		PLAN NOs :	DP 1155484	Piy Liu			
		Street, Casino Detail Pl		DA	SOURCE OF FLOOD INFO:	BENCH MARK A SURVEY CONTROL MARK SSM	OTHER:	700m² & 654.9m²	SURVEYORS Registered Surveyor	Detail Survey	SITE LAYOUT JOB	3 SHT. 1 OF 1
	24-05-2022	DATE NOTATION/AMENDMENT 24-05-2022 Initial Detail Plan Easement Note Updated	24-05-2022	24-05-2022 Initial Detail Plan Easement Note Updated	24-05-2022 Initial Detail Plan Easement Note Updated	24-05-2022 Initial Detail Plan Easement Note Updated FILE FILE SIZE (MB) CHECKED BY	24-05-2022 Initial Detail Plan Easement Note Updated	Initial Detail Plan Easement Note Updated Initial Detail Plan Easement Note Updated Initial Detail Plan Easement Note Updated Initial Detail Plan Initial Detail	24-05-2022 Initial Detail Plan Easement Note Updated DATUM: AHD ORIGIN OF DATUM: PM **** DATUM: AHD ORIGIN OF DATUM: PM **** LAND TITLE INFORMATION The commendation of	24-05-2022 Initial Detail Plan Easement Note Updated Initial Detail Plan Initial Plan Initial Detail Plan Initial P	Initial Detail Plan Easement Note Updated Initial Detail Plan Initial Pl	ACAD-151687 - 75-77 Sheppard Street, Casino Flat Survey or Survey Sur

DP 776531

VACANT

DETERMINED by the NSW Land and Housing Corporation on:

25 November 2023

GENERAL HOUSING 75-77 SHEPPARD STREET, **CASINO**

NOTIFICATION PLANS



STREET PERSPECTIVE: 75 - 77 SHEPPARD STREET, CASINO



 $\Delta \Omega \Omega \Delta$ Barry Rush & Associates Pty Ltd **NOTIFICATION - COVER PAGE** 75-77 Sheppard Street, CASINO LOTS 761 & 762 in DP 1155484

REV: DATE:


PROJECT NO:

13/06/23

BGZEG

N01

SHEET:

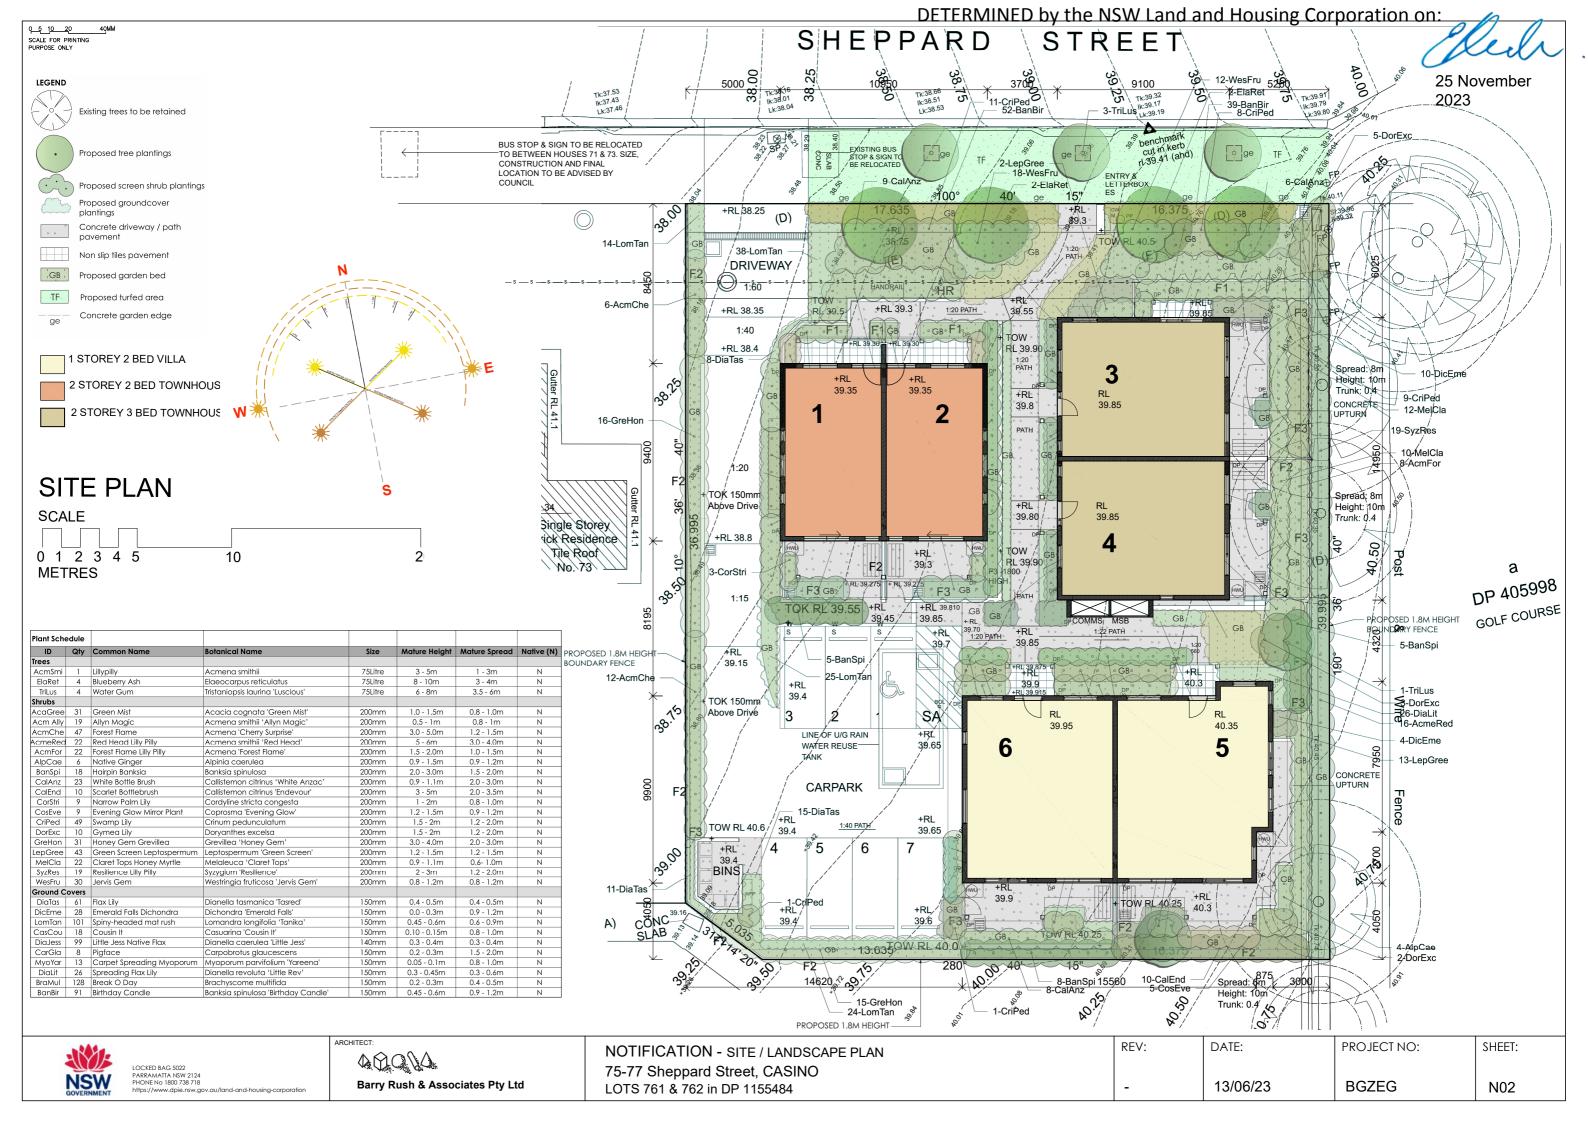






DEVELOPMENT DATA

Job Reference	BGZEG
Locality / Suburb	Casino
Street Address	75-77 Sheppard Sreet
Lot & DP	Lots 2761 and 762 in DP 1155484
Site Area	1354.9 m² by title
Existing Lots	2
Proposed GFA	505.6 m²
No. of Dwellings	4 x 2 Bed + 2 x 3 Bed = 6 Dwellings

	Control	Requirement	Proposed
HEIGHT	Richmond Valley Council LEF	8.5m	6.3m to ceiling
	Housing SEPP	9.0m	7.8m to top of roof
	LRHDG Rear 40% of Site	4.5m	rear 40% of site < 4.5m
FSR	Richmond Valley Coast DCP	0.5:1 (631.5m²)	0.37:1 (505.6m²)
	Housing SEPP	0.5:1	0.37:1 (505.6m²)
LOT SIZE & WIDTH	Richmond Valley Coast DCP	Site 1000 m² Width 20m	Site 1354.9m² Width 34m
SETBACKS	Richmond Valley Coast DCP multi - dwelling	Front Setback 6.0m	6.0-8.5m to Building
	LRHDG	Side Setback = H - 3m	3.0-5.2m to Building East (front) - 5.2m to building 3.2m to awning East (rear) - 3m West - 5m
	LRHDG	Rear Setback = 6m	4m to Building 2m to awning
PARKING	Housing SEPP	1 x(no. 2 Beds) = 4 1.5 x (no. 3 Beds) = 3	7 car spaces
BICYCLE PARKING	LRHDG	1 space per Dwelling = 6	Bicycles to be stored in unit POS
POS Private open space	LAHC Dwelling Requirements	1 bed Dwelling = 8m² 2 bed Dwelling = 10m² 3 bed Dwelling = 12m²	All POS > 25m²
	Richmond Valley Coast DCP multi - dwelling	1+2 bed Dwelling = 16m ² 3 bed Dwelling = 25m ²	All POS > 25m²
SOLAR ACCESS	Housing SEPP	70% for 3hrs in Mid-Winter = 4.2	5 = 83%






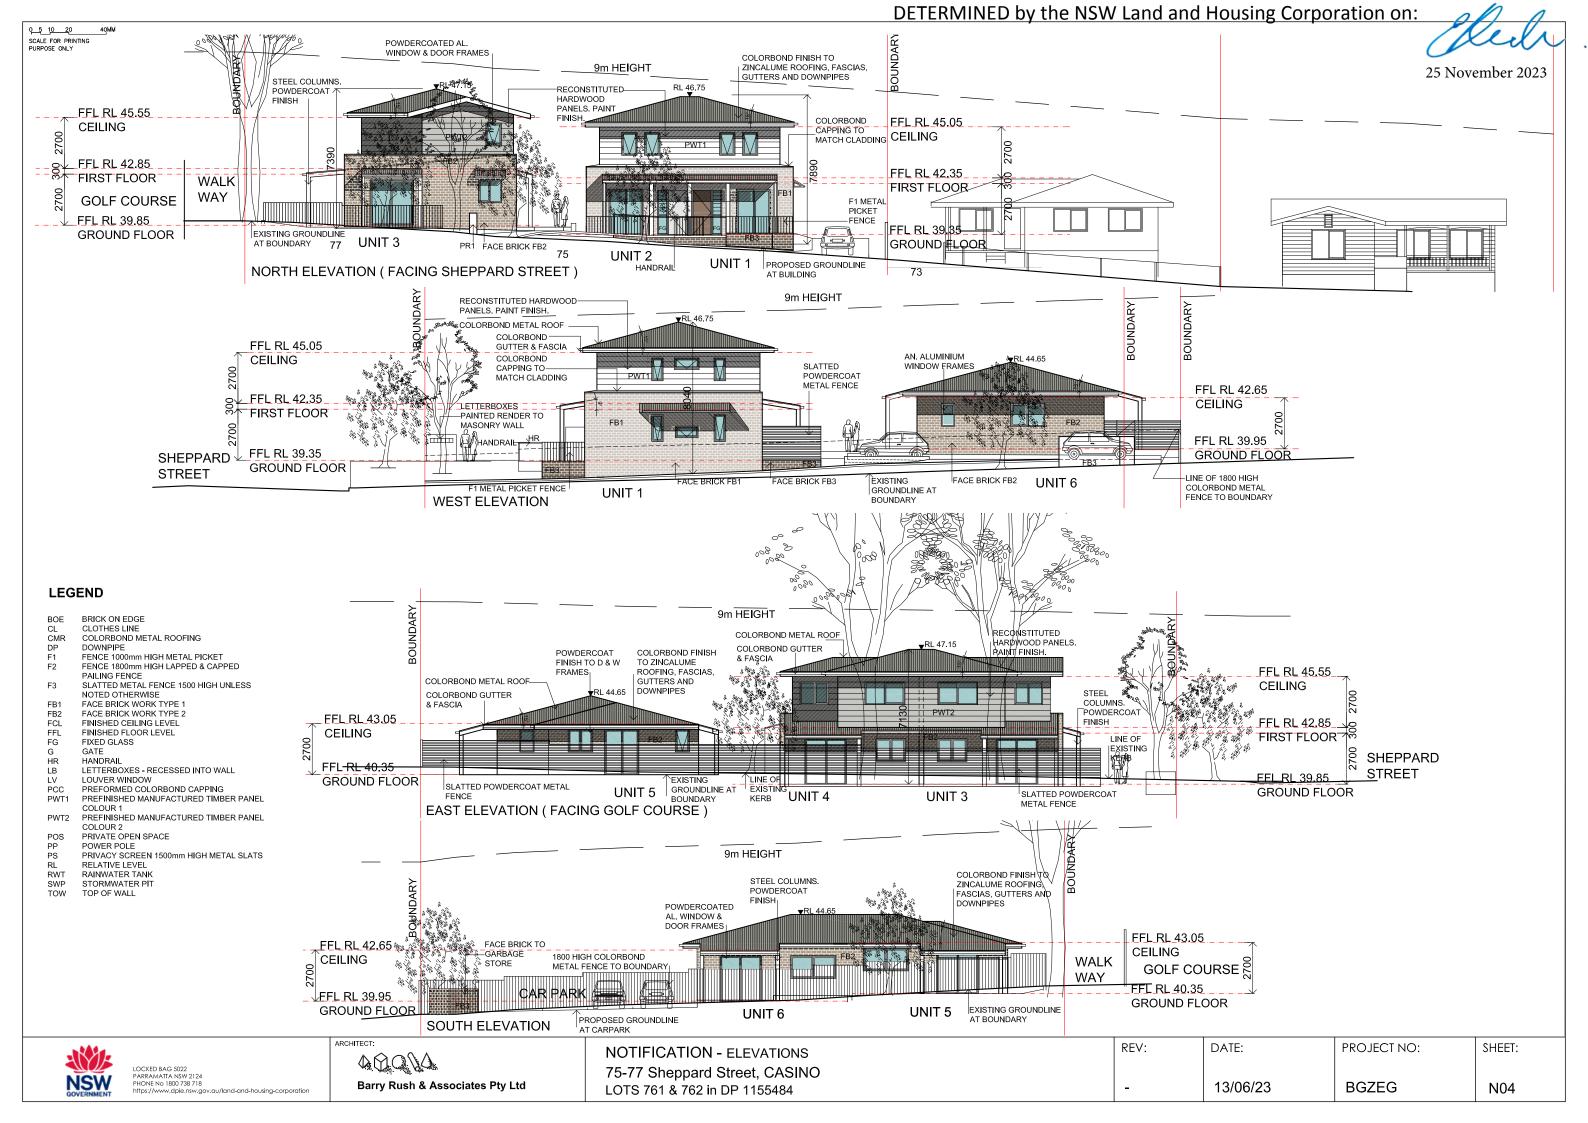

Kedr

25 November 2023

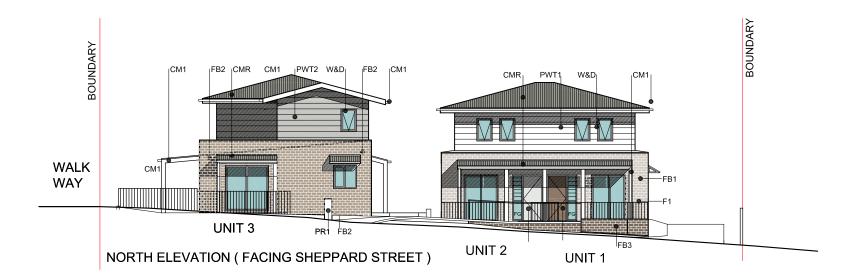

FINISHES SCHEDULE


CODE	LOCATION	DESCRIPTION	COLOUR
CMR	ROOFING/	CORRUGATED COLORBOND METAL ROOFING	BASALT
CM1	FASCIA, GUTTER, AWNING, COLUMNS & BEAMS	METAL COLORBOND & GALV STEEL	WINDSPRAY
FB1	WALLS UNITS 1 & 2	FACE BRICK light warm	PGH BRICK VELOUR "CRUSHED GREY"
FB2	WALLS UNITS 3, 4, 5 & 6	FACE BRICK light off white	PGH BRICK VELOUR "MINERAL"
FB3	SITE WALLS & BIN STORAGE	FACE BRICK medium warm	PGH BRICK OPALINE "TOURMALINE"
PR1	LETTERBOX WALL	PAINTED RENDER	DULUX LEXICON HALF
FC1	EAVES LINING & SOFFIT	PAINTED FIBER CEMENT SHEETING	DULUX LEXICON HALF

CODE	LOCATION	DESCRIPTION	COLOUR
PWT1	FIRST FLOOR WALLS UNITS 1&2	RECONSTITUTED HARDWOOD PLANKS -PRE SEALED. PAINT FINISH	WATTYL "WINTER SKY"
PWT2	FIRST FLOOR WALLS UNITS 3&4	RECONSTITUTED HARDWOOD PLANKS -PRE SEALED. PAINT FINISH	WATTYL "SEQUOIA DUSK"
W & D	WINDOWS & GLASS DOORS FRAMING	POWEDERCOATED ALUMNIUM	WHITE
PS	PRIVACY SCREEN	ALUMINIUM HORIZONTAL SLATTED BARS	SURFMIST
F1	METAL FENCES TO FRONT POS	POWDERCOATED METAL	DULUX WINDSPRAY
F2	FENCE	1800 HIGH COLORBOND METAL FENCE	DULUX WINDSPRAY
F3	SLATTED METAL FENCES TO REAR POS	1500 HIGH (UNLESS NOTED OTHERWISE) SLATTED POWDERCOATED METAL FENCE	DULUX WINDSPRAY
D1	FRONT DOOR UNITS 1, 3, 5	PAINT FINISH TO ENTRY DOOR	DULUX "TERRAIN"
D2	FRONT DOOR UNITS 2, 4, 6	PAINT FINISH TO ENTRY DOOR	DULUX "LEXICON HALF"




Gledr

25 November 2023

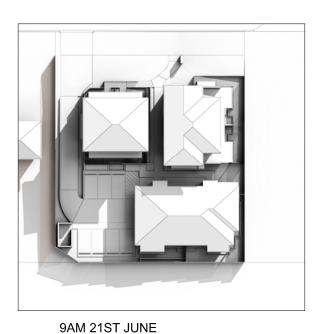



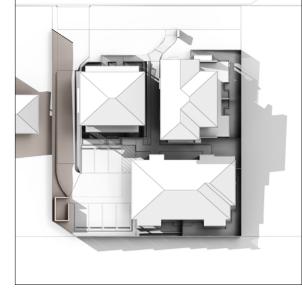

12NOON 21ST JUNE

3PM 21ST JUNE

